REMAX GOLD COAST

725 S. VICTORIA AVE VENTURA CA 93003

CONSTRUCTION LEGEND

- DOOR NUMBER

WINDOW TAG

ELEVATION

—(A) COLUMN GRID

DATUM POINT

DETAIL NUMBER

SHEET WHERE SHOWN

SECTION NUMBER

AREA TO BE DETAILED

- AREA TO BE DETAILED

SHEET WHERE SHOWN

REVISION AREA

REVISION NUMBER

— ELEVATION NUMBER

NOTES

SHEET WHERE

SHOWN

RE/MAX
Gold Coast

725 S. VICTORIA AVE VENTURA CA 93003

nest


legend

architecture inc.

9314 venice blvd. culver city california 90232 310 559 pn 9900

pennsylvania 17046 717 274 pn 9551



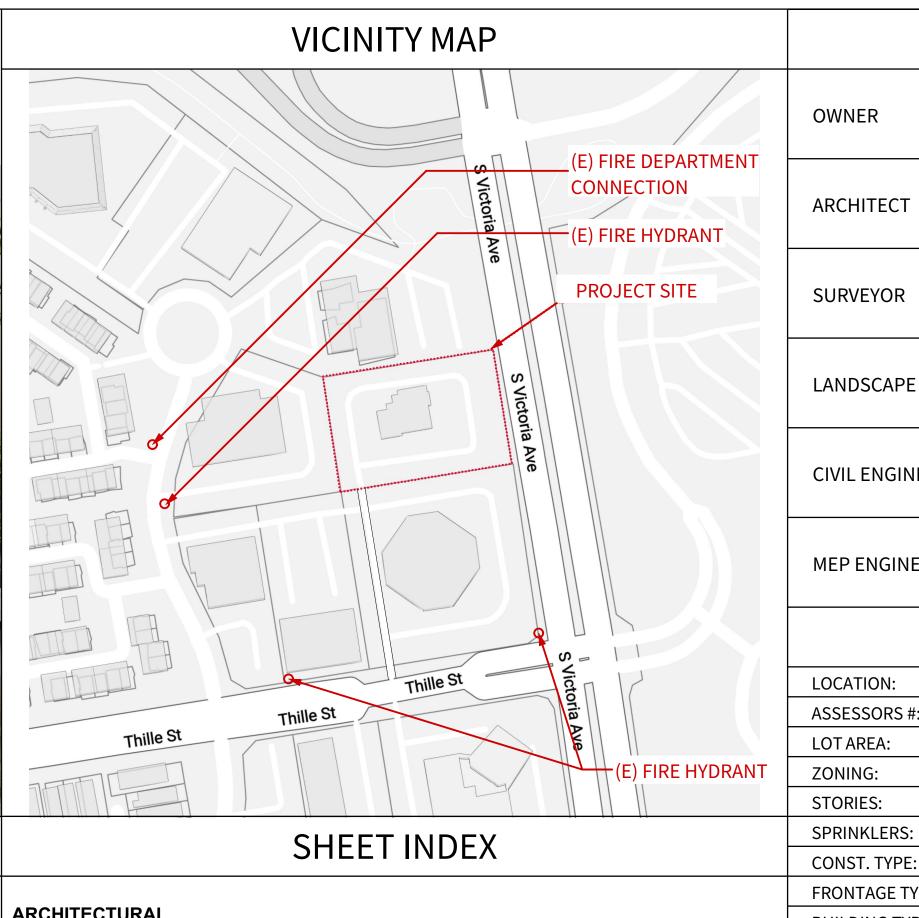

Fire Sprinklers to be provided per code P101.3 of San Buenaventura Municipal Code

OWNER	MICHAEL SIPES, REMAX GOLD COAST TEL: 805-443-2390 3550 HARBOR BLVD, OXNARD, CA 93035				
ARCHITECT	NEST ARCHITECTURE INC CONTACT: KIP KELLY, AIA TEL: (310) 559-9900 FAX: (310) 559-7722 9314 VENICE BLVD, CULVER CITY, CA 90232				
SURVEYOR	WM SURVEYS INC CONTACT: WILLIAM L MEAGHER TEL: (805) 677-4850 2747 SHERWIN AVE #12, VENTURA, CA 93003				
LANDSCAPE ARCHITECT	STEVEN P. ELLBERG CONTACT: (805) 794-6602				
CIVIL ENGINEER	T.B.D.				
MEP ENGINEER	T.B.D.				
LEGAL DESCRIPTION					
LOCATION: 725 S. VIC	TORIA AVE VENTURA, CA 93003				
ASSESSORS #: # 1850190	05				

51,444 SQ. FT. -or- 1.181 ACRES

C2PD

YES

SITE SURVEY

UTILITY PLAN

A2.03

A2.04

PROJECT TEAM

		SSI	ue:	s a	nd	re	vis	ior	าร	
CHANGE	Approved by	КР	ΚΡ							
2,362 SQ. FT.	Checked by	KN	X N							
2,200 SQ. FT. 2,950 SQ. FT. 5,150 SQ. FT. 3,720 SQ. FT. 536 SQ. FT.	ISSUE	ISSUE FOR PLAN CHECK	PLANNING RESUBMITTAL							
	DATE	11/29/2021	2/8/2022							
	<u> </u>	03	90							
	'							atu	re	
	No. C-20478 10-31-2023 RENEWAL DATE									

project: 725 S VICTORIA AVE

description

drawn

project number * PROJECT NUMBER *

A1.01 TITLE SHEET / GENERAL

INFO

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AS NOTED

drawing number

	ANGLE	GL	GLASS	SL	SLIDING	
@	AT	GLB	GLUE LAMINATED	SPEC	SPECIFICATION	
AB	ANCHOR BOLT	GR	BEAM GRADE	SPL	SPLASH	
ABV	ABOVE	GYP BD	GYPSUM WALLBOARD	SQ ST. STL. S.S.	SQUARE STAINLESS STEEL	
AC	AIR CONDITIONING	GIF DD	GTF 30M WALLBOARD	STD	STANDARD	
AD ADD'L	AREA DRAIN ADDITIONAL	НВ	HOSE BIBB	STL	STEEL	
ADD L ADJ	ADJUSTABLE	HC	HOLLOW CORE	STOR	STORAGE	
ALUM	ALUMINUM	HD	HOLDDOWN	SUSP SYM	SUSPENDED SYMMETRICAL	
APPVL	APPROVAL	HORIZ HRDWD	HORIZONTAL HARDWOOD			
ASPH	ASPHALT	HRDW	HARDWARE	T	TREAD	
		HT	HEIGHT	T&G	TONGUE & GROOVE	
		HTR	HEATER	TA T.B.D.	TENSION ANCHOR TO BE DETERMINED	
BD	BOARD	ID	INSIDE DIAMETER	TD.	TOP OF DRAIN	
BLKG	BLOCKING	INSUL INT	INSULATION INTERIOR	TEL	TELEPHONE	
BM	BEAM	I/S	INSIDE	TER	TERRAZZO	
BN	BOUNDARY NAILING	JST	JOIST	THK	THICK	
BOT	ВОТТОМ	JT	JOINT	THR	THRESHOLD	
		LAM	LAMINATE	TOC	TOP OF CURB	
C4.D/=	CARINITE	LAW	LAVATORY	TP	TOP OF PAVING	
CAB'T	CABINET	LT	LIGHT	TV	TELEVISION	
CEM	CATCH BASIN	MAY	MANJAMITA	TW	TOP OF WALL	
CEM	CEMENT	MAX	MAXIMUM	₩PP.	₩₩₽ŒNLTIFIED	
C.T. CI	CERAMIC TILE	MANUF.	MANUFACTURER	LINE	FLYING OBJECT	
CI CJ	CAST IRON CEILING JOIST	M.B. MC	MACHINE BOLT MEDICINE CABINET	UNF UNO	UNFINISHED UNLESS NOTED	
CL or 🛭	CENTER LINE	MECH	MECHANICAL	0.10	OTHERWISE	
CLG	CEILING	MTL	METAL			
CL.	CLOSET	MICRO	MICROWAVE OVEN	VERT	VERTICAL	
CLR	CLEAR	MIN	MINIMUM	W	WASHER	
CNTR	COUNTER	MISC	MISCELLANEOUS	W/	WITH	
COMB ANC	COMBINATION	MLDG	MOLDING	WC	WATER CLOSET	
	ANCHOR	MO	MASONRY OPENING	WD	WOOD	
COMP	COMPRESSOR	MTD	MOUNTED	WH W/O	WATER HEATER WITHOUT	
CONT	CONTINUOUS	(MI)G	MEWNTING	W/O WP	WATER-PROOF	
CRN	CROWN	NIC 1	NOT IN CONTRACT	WSCT	WAINSCOT	
CTSK	COUNTERSUNK	NO. 1 NOM	NUMBER NOMINAL	WT	WEIGHT	
		NTS	NOT TO SCALE			
D	DRYER	0/	OVER			
D DBL	DOUBLE	OBS	OBSCURE			
DEMO	DEMOLISH/	OC or O.C.	ON CENTER			
PLINO	DEMOLISH/ DEMOLITION	OD	OUTSIDE DIAMETER			
DET	DETAIL	O.H.	OPPOSITE HAND			
DIA or ø	DIAMETER	OPNG	OPENING			
DIM	DIMENSION	OPP	OPPOSITE			
DN	DOWN	<u></u> ₽/S	PLUSBEMINUS			
DP	DEEP	PAN	PANTRY			
ĒŘ ELEC	EACH DOOR ELECTRIC	PL	PLATE			
EPEC EFEC	ELECTRIC EDGENAILING	PLAS	PLASTIC			
₽WCL	ENDER HOUSE HER	LAM	PLASTIC LAMINATE			
Б́М̂С	E@BAWING	PLYWD	PLYWOOD			
DQVGI (PS) EVV.	EQRAMENTS FACH WAY	PR	PAIR	SUOD.		
Ð₩R (E)	EAGHAWER EXISTING	PRHA	PHILLIPS RED HEAD AND	HOR		
EXT	EXRERIOR	PT P.T.	POINT			
FAU	FORCED AIR UNIT	₽TDF	PRESSURE TREATED DO	UGLAS FIR		
FD	FLOOR DRAIN	RAD	RADIUS			
FG	FUEL GAS	RD REF	ROOF DRAIN REFRIGERATOR			
FXGL	FIXED GLASS	REG	REGISTER			
FIN	FINISH FLOOP JOIST	REINF	REINFORCED			Г
FJ EI	FLOOR JOIST	REQ'D	REQUIRED			
FL FLR	FLOOR LINE FLOOR	RESIL	RESILIENT			
FLOUR	FLUORESCENT	RJ RM	ROOF JOIST ROOM			
FN	FIELD NAILING	RO	ROUGH OPENING			
FND	FOUNDATION	RR	ROOF RAFTER			

SHEAR BOLT SOLID CORE

SHELF & POLE

SHOWER

SIMILAR

SMOKE DETECTOR

SHELF & DOUBLE POLE

SECURITY OPENING

FACE OF CONCRETE

FIRE PLACE SD
FIBER REINFORCED PLASTIC SEC OPG

SH & P

FACE OF STUD

FOOT OR FEET

FOOTING FURRING

FREEZER

GAUGE

GALVANIZED

GARBAGE DISPOSAL

GALVANIZED IRON

GALV GD


REFLECTED	CEILING LEGEND	POWER/0	COMMUNICATIONS
	LIGHT SWITCH		<u>LEGEND</u>
	3-WAY SWITCH	+42"	DUPLEX WALL OUTLET NON STANDARD MTG HT.
D	DIMMER SWITCH	WP	WEATHER-PROOF DUPLEX WALL OUTLET (GFI)
\bigcirc	WALL WASHER	Œ	GFI RECEPTACLE
	RECESSED DOWNLIGHT	GFI	OFFICE OF THE PROPERTY OF THE
\ - \	CEILING MOUNTED PENDANT WALL MOUNTED UPLIGHT		QUADRUPLEX WALL OUTLET DUPLEX WALL OUTLET,
	FLUORECENT LIGHT	$\overline{\bullet}$	1/2 SWITCHED
•	FIXTURE SPRINKLER HEAD		DEDICATED QUADRUPLEX WALL OUTLET
	EMERGENCY LIGHT		DEDICATED WALL OUTLET
SD	SMOKE DETECTOR	$\overline{}$	(SEP. CIRCUIT) SPECIAL
CO	CARBON MONOXIDE DETECTOR	\bigoplus	220v RECEPTACLE
S&CD	COMBINATION CARBON MONOXIDE AND SMOKE DETECTOR	K	DATA OUTLET
	LINEAR SLOT DIFFUSER		TELEPHONE OUTLET
	LINEAR SEOT BITTOSER		
	SUPPLY DIFFUSER	K	COMBINATION TELEPHONE AND DATA OUTLET
	DETUDNI CDILI	+60"	PLUG MOLD, MOUNTING HEIGHT
	RETURN GRILL		FLUSH MTD. FLOOR DUPLEX OUTLET
S	EXHAUST FAN		FLUSH MTD. FLOOR QUADRUPLEX OUTLET
-00	EXHAUST FAN/ LIGHT COMBO		FLUSH MTD. FLOOR DATA OUTLET
	TRACK LIGHTING		FLUSH MTD. FLOOR TELEPHONE OUTLET
+6'-3"	WALL SCONCE	<u></u>	FLUSH MTD. FLOOR JUNCTION BOX
	PROJECTION SCREEN (RECESSED)		FLUSH MTD. FLOOR TELE/DATA OUTLET
8'-0"	CEILING HEIGHT	$\top \vee$	CABLE TV OUTLET
8'-0"	CEILING HEIGHT TRANSITION		


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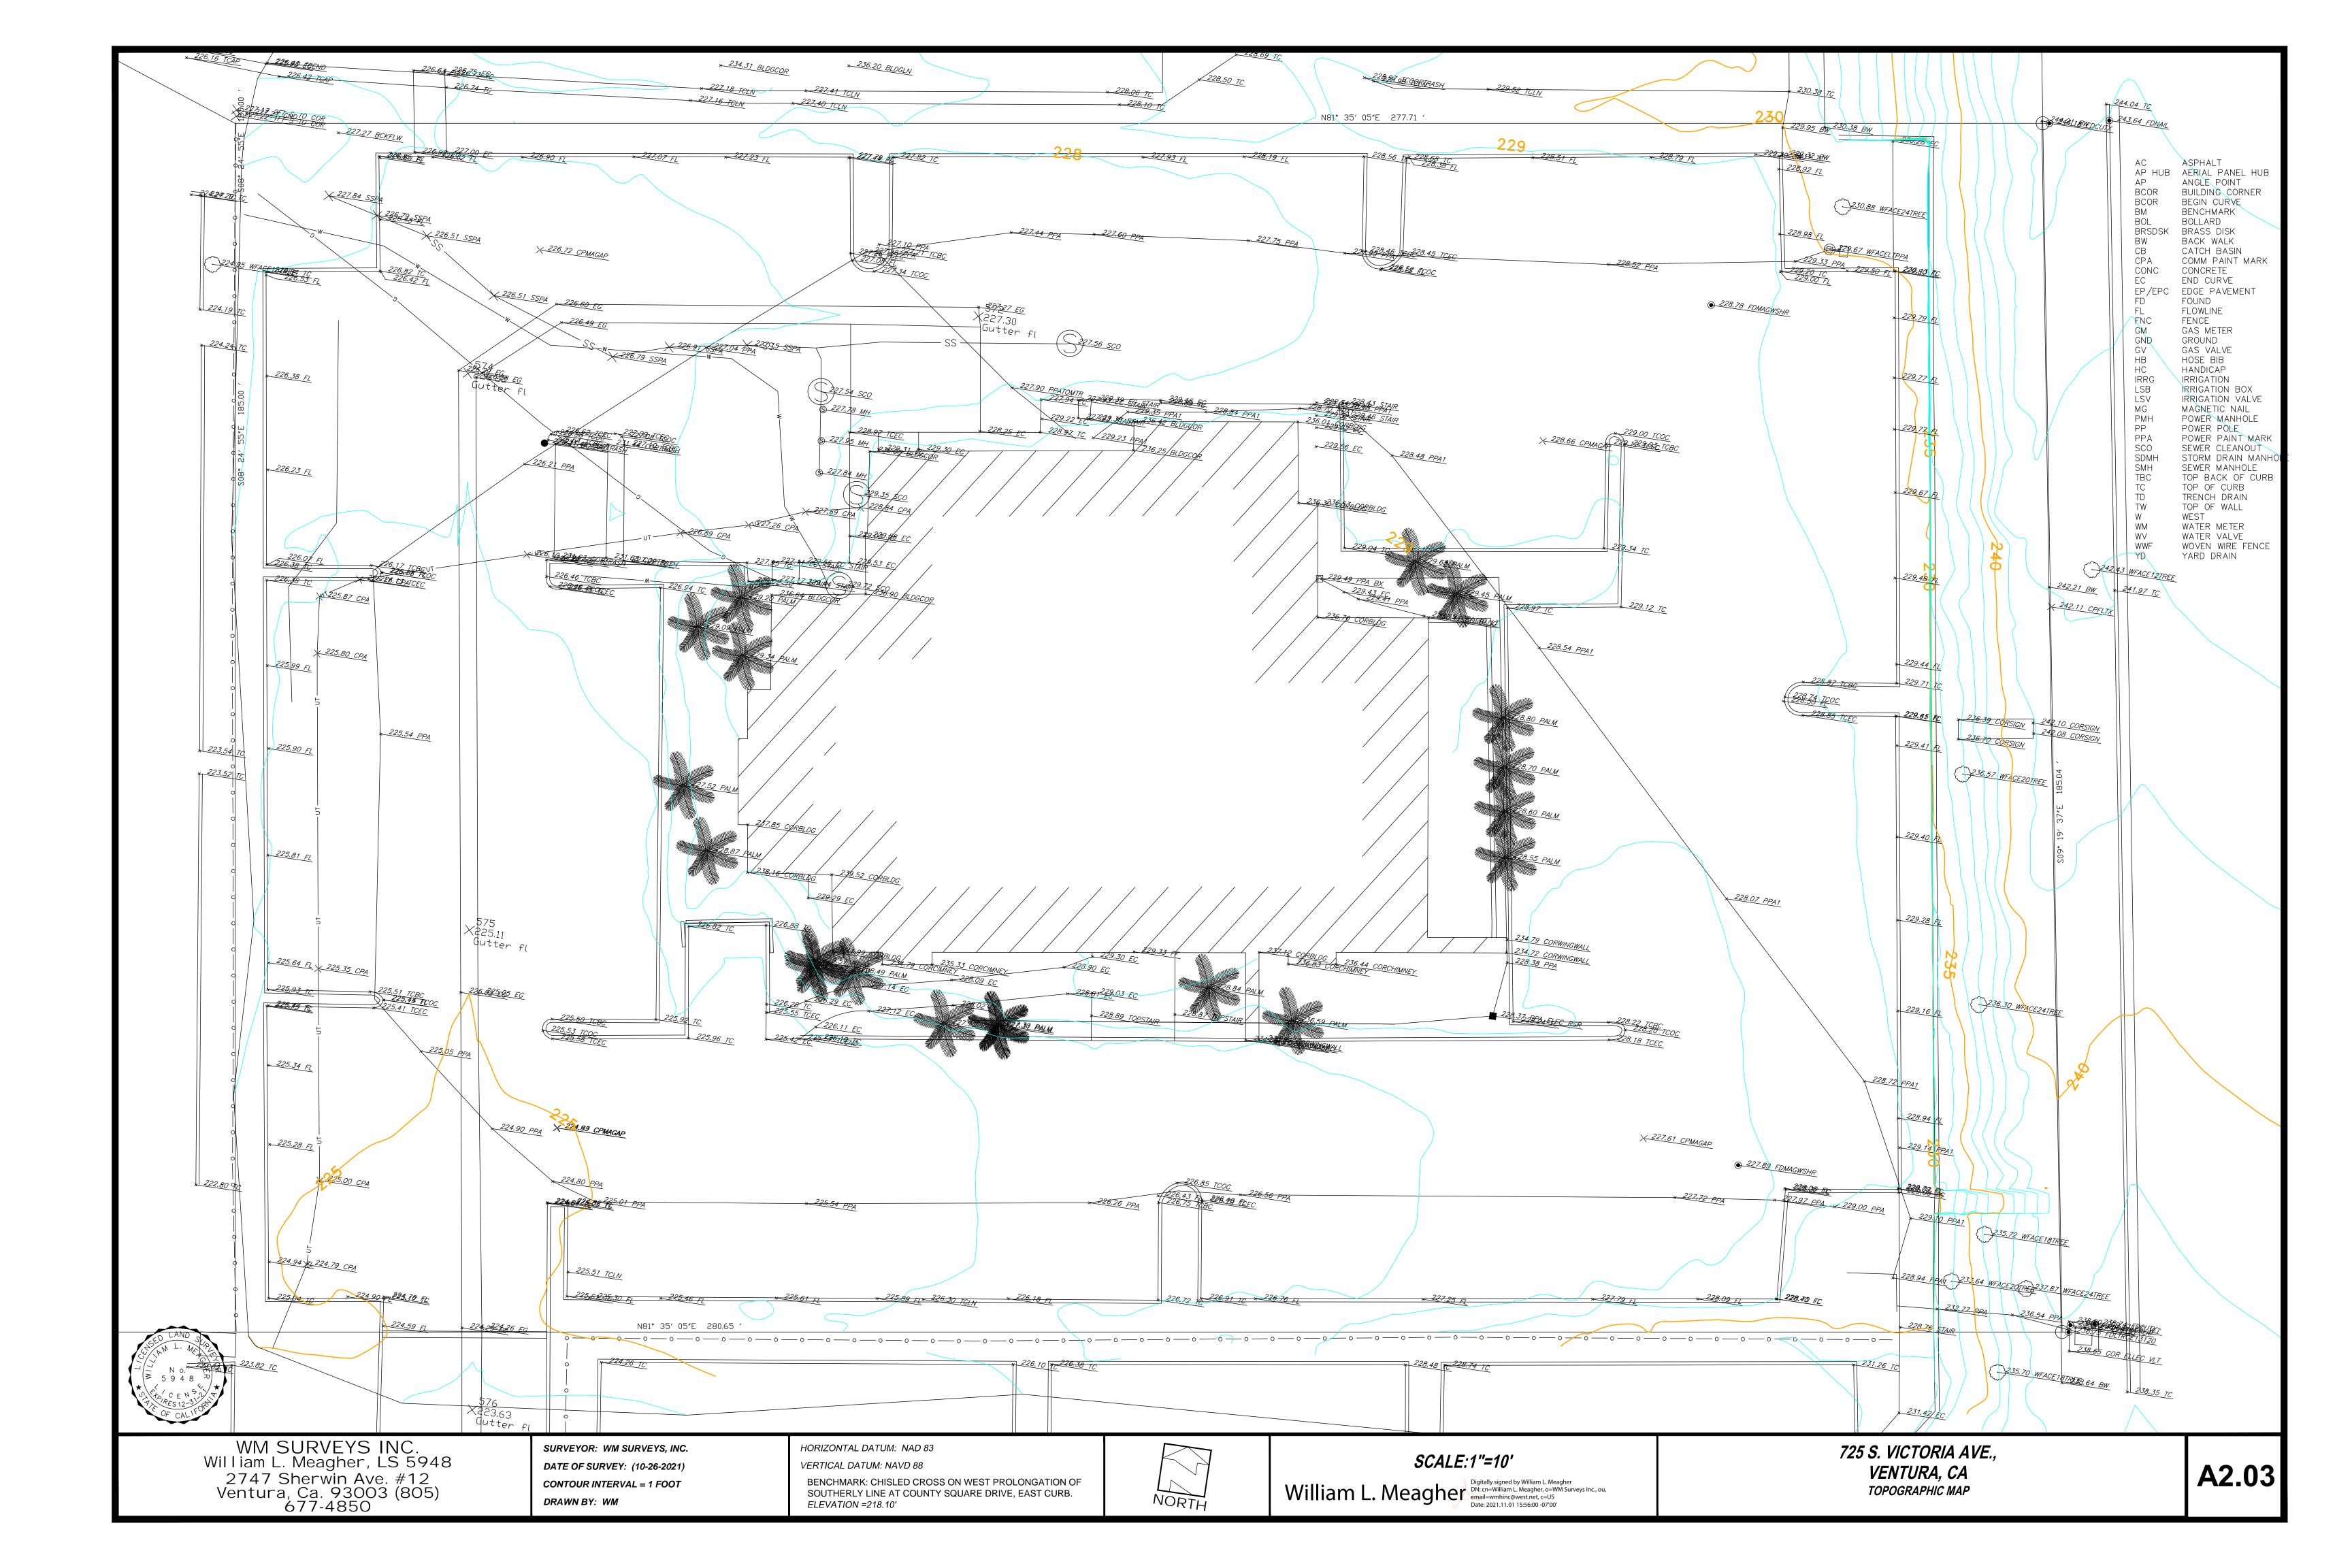
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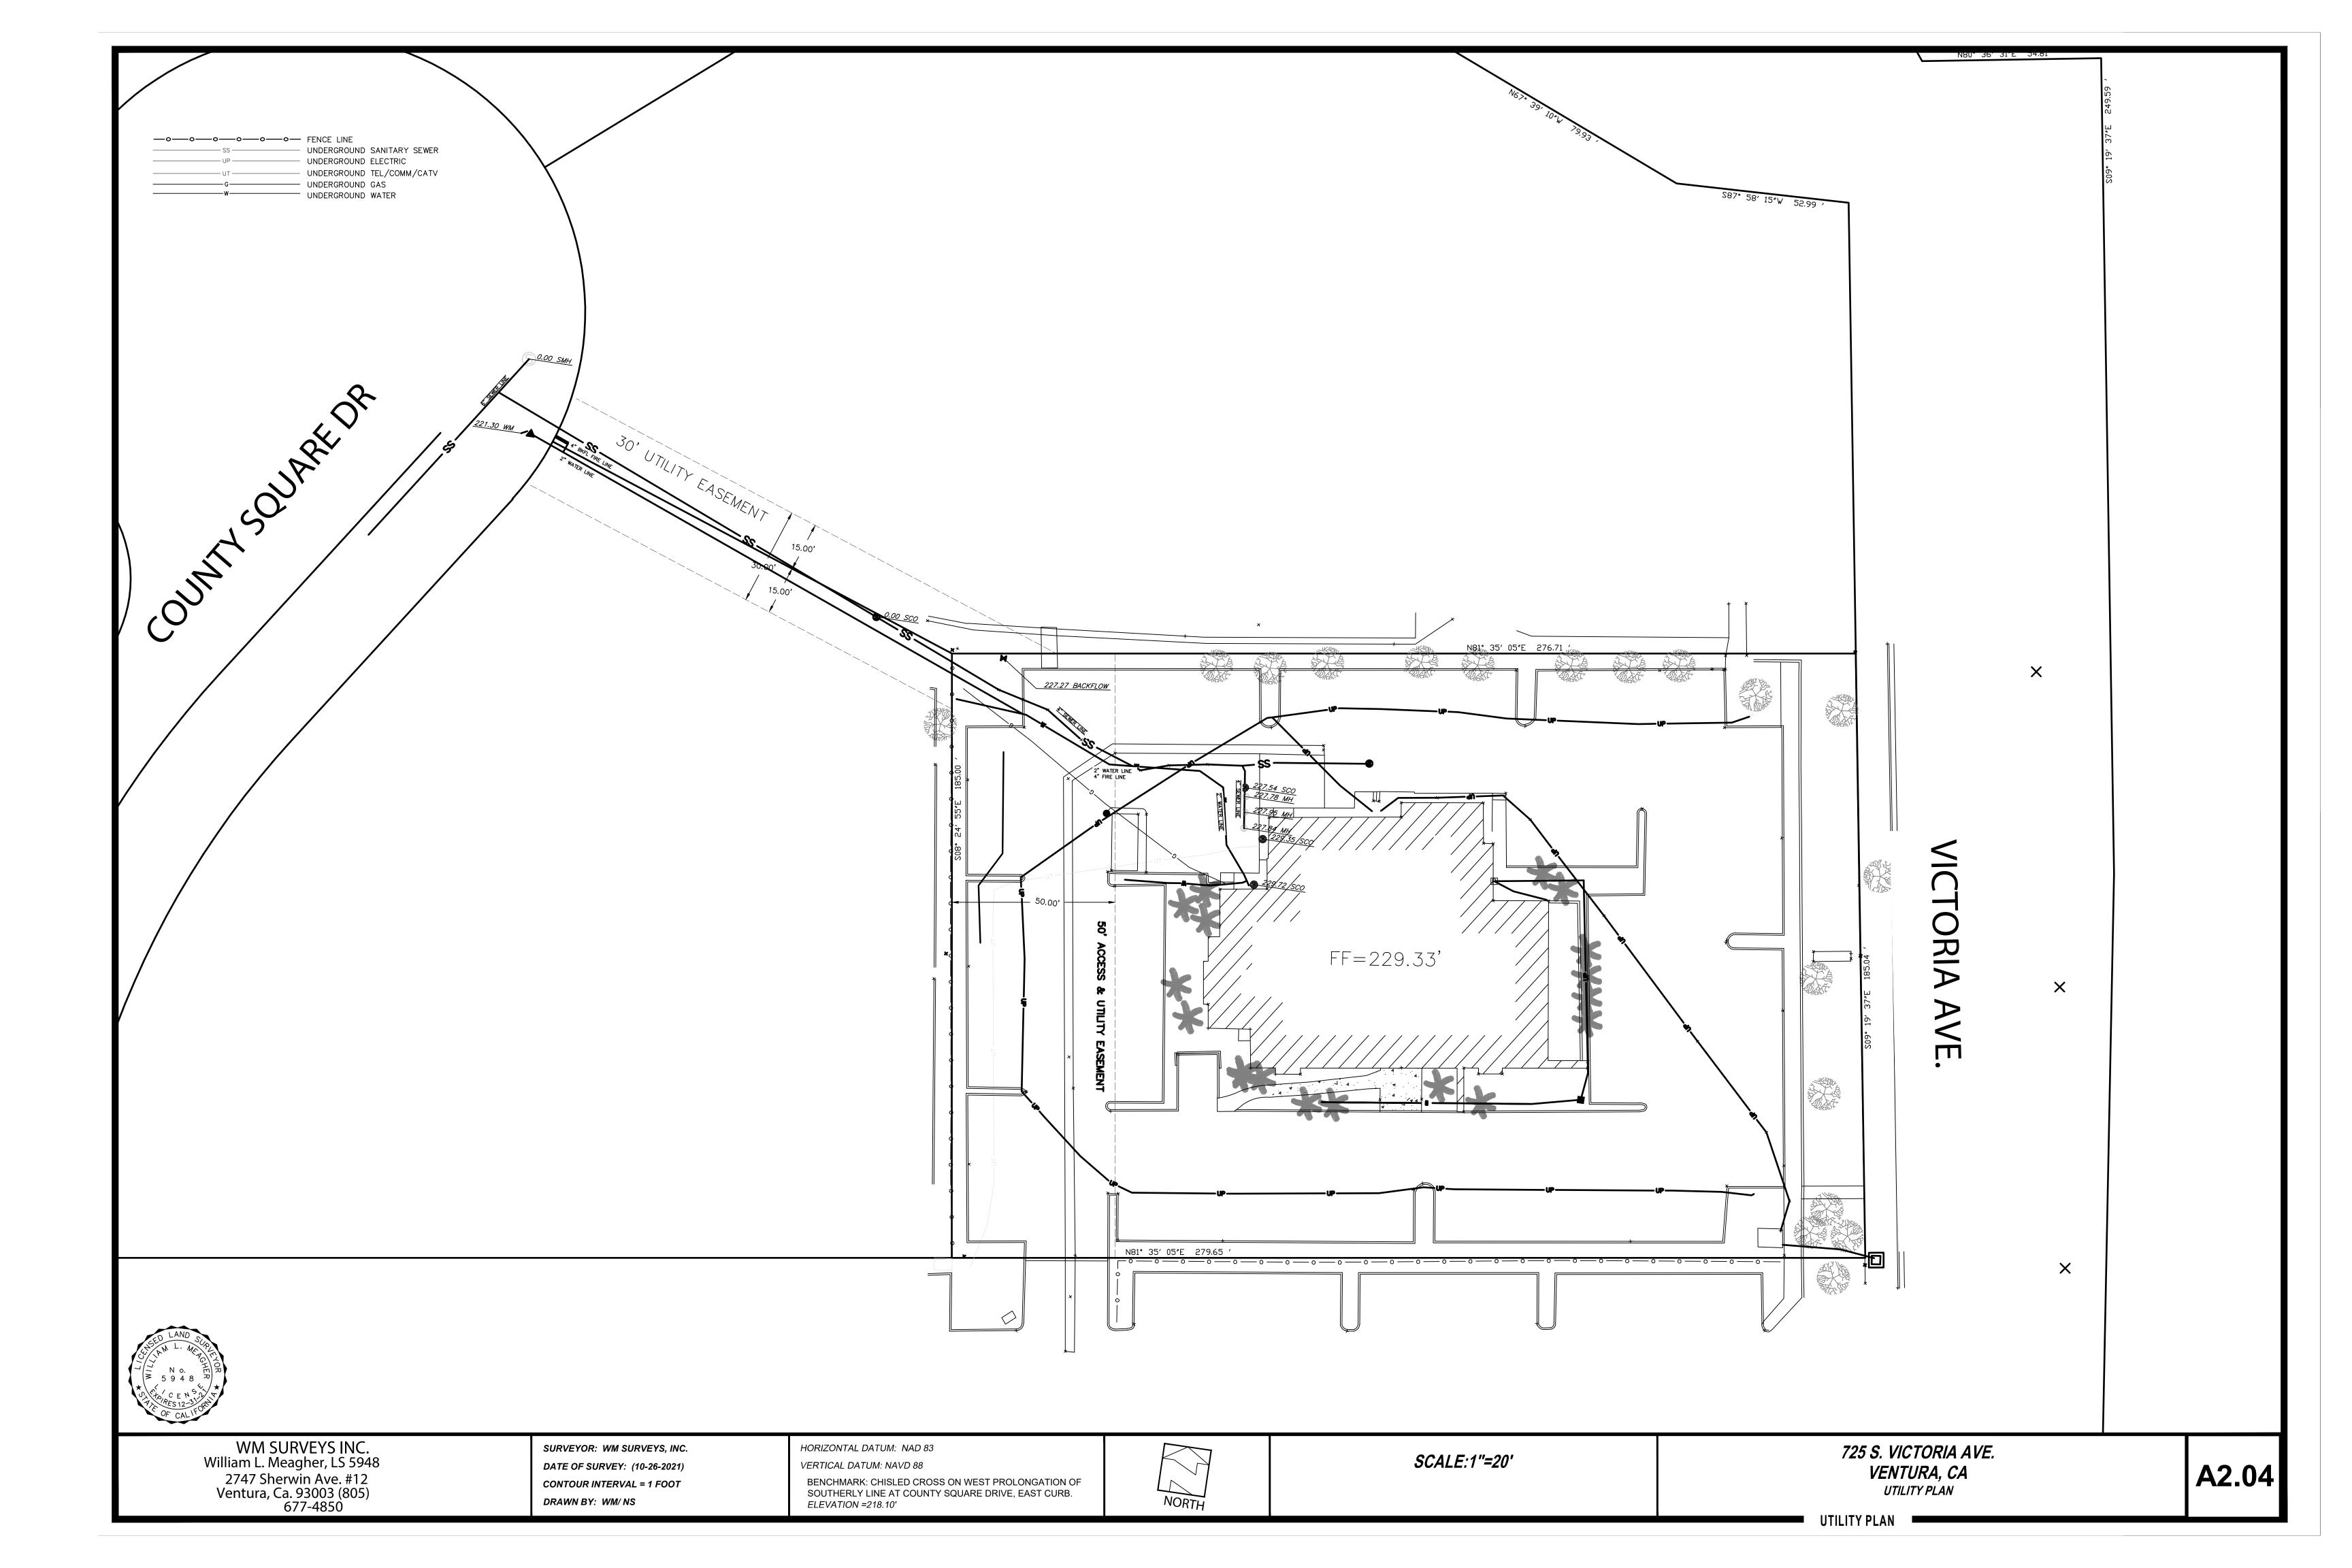
THERMOSTAT


	SHEET INDEX	SPRINKL	SPRINKLERS: YES					
	SUEET INDEX	CONST.	CONST. TYPE: V					
		FRONTA	FRONTAGE TYPE: GRAND LOBBY ENTRY					
ARCHITE	CTURAL	BUILDIN	BUILDING TYPE: COMMERCIAL BLOCK					
A1.01	TITLE SHEET / GENERAL INFO							
A2.01	EXISTING SITE DEMO PLAN		AREA CALCULATIO			_		
A2.02	PROPOSED SITE PLAN	AREA	A (SQ.FT.)	EXISTING	PROPOSED			
A2.03	SITE SURVEY							
A2.04	UTILITY PLAN	BUILDIN	G FOOTPRINT	7,144 SQ. FT.	9,506 SQ. FT.			
A3.10	1ST FLOOR DEMO PLAN	FIRST FI	FIRST FLOOR 6,900 SQ. FT. 9,					
A3.11	1ST FLOOR PLAN	SECOND	FLOOR	1,950 SQ. FT.	4,900 SQ. FT.	ĺ		
A3.20	2ND FLOOR DEMO PLAN	TOTAL		8,850 SQ. FT.	14,000 SQ. FT.	Ī		
A3.21	2ND FLOOR PLAN							
A3.30	ROOF DEMO PLAN	PAVED	PARKING/WALKWAYS	34,990 SQ. FT.	31,720 SQ. FT.	Γ		
A3.31	ROOF PLAN	LANDSO	CAPE	9,632 SQ. FT.	10,168 SQ. FT.	Γ		
A4.01	BUILDING ELEVATIONS (NORTH & WEST)					Ī		
A4.02	BUILDING ELEVATIONS (EAST & SOUTH)					ſ		
A5.01	BUILDING SECTIONS		DADIZINIC					
A5.02	BUILDING SECTIONS			PARKING				
A5.03	BUILDING SECTIONS	EXISTIN	NG SPACES		103 SQ. FT.			
A5.04	BUILDING SECTIONS	REQUII	RED SPACES @1/300 SF		47 SQ. FT.			
A5.05	BUILDING SECTIONS		<u> </u>					
A8.04	CITY STANDARD DETAIL					_		
A9.01	RENDERINGS	LANDSC	APE					
A9.02	SUN STUDY	L.1	L.1 (E) LANDSCAPE INVE		ON PLAN			
A9.03	MATERIAL BOARD	L.2						
		L.3	IRRIGATION DETAIL	S & (SHORT FORMAT) SPECS			
		L.4		S & (SHORT FORMAT	•	_		
				·	<u>- </u>	_		
						_		
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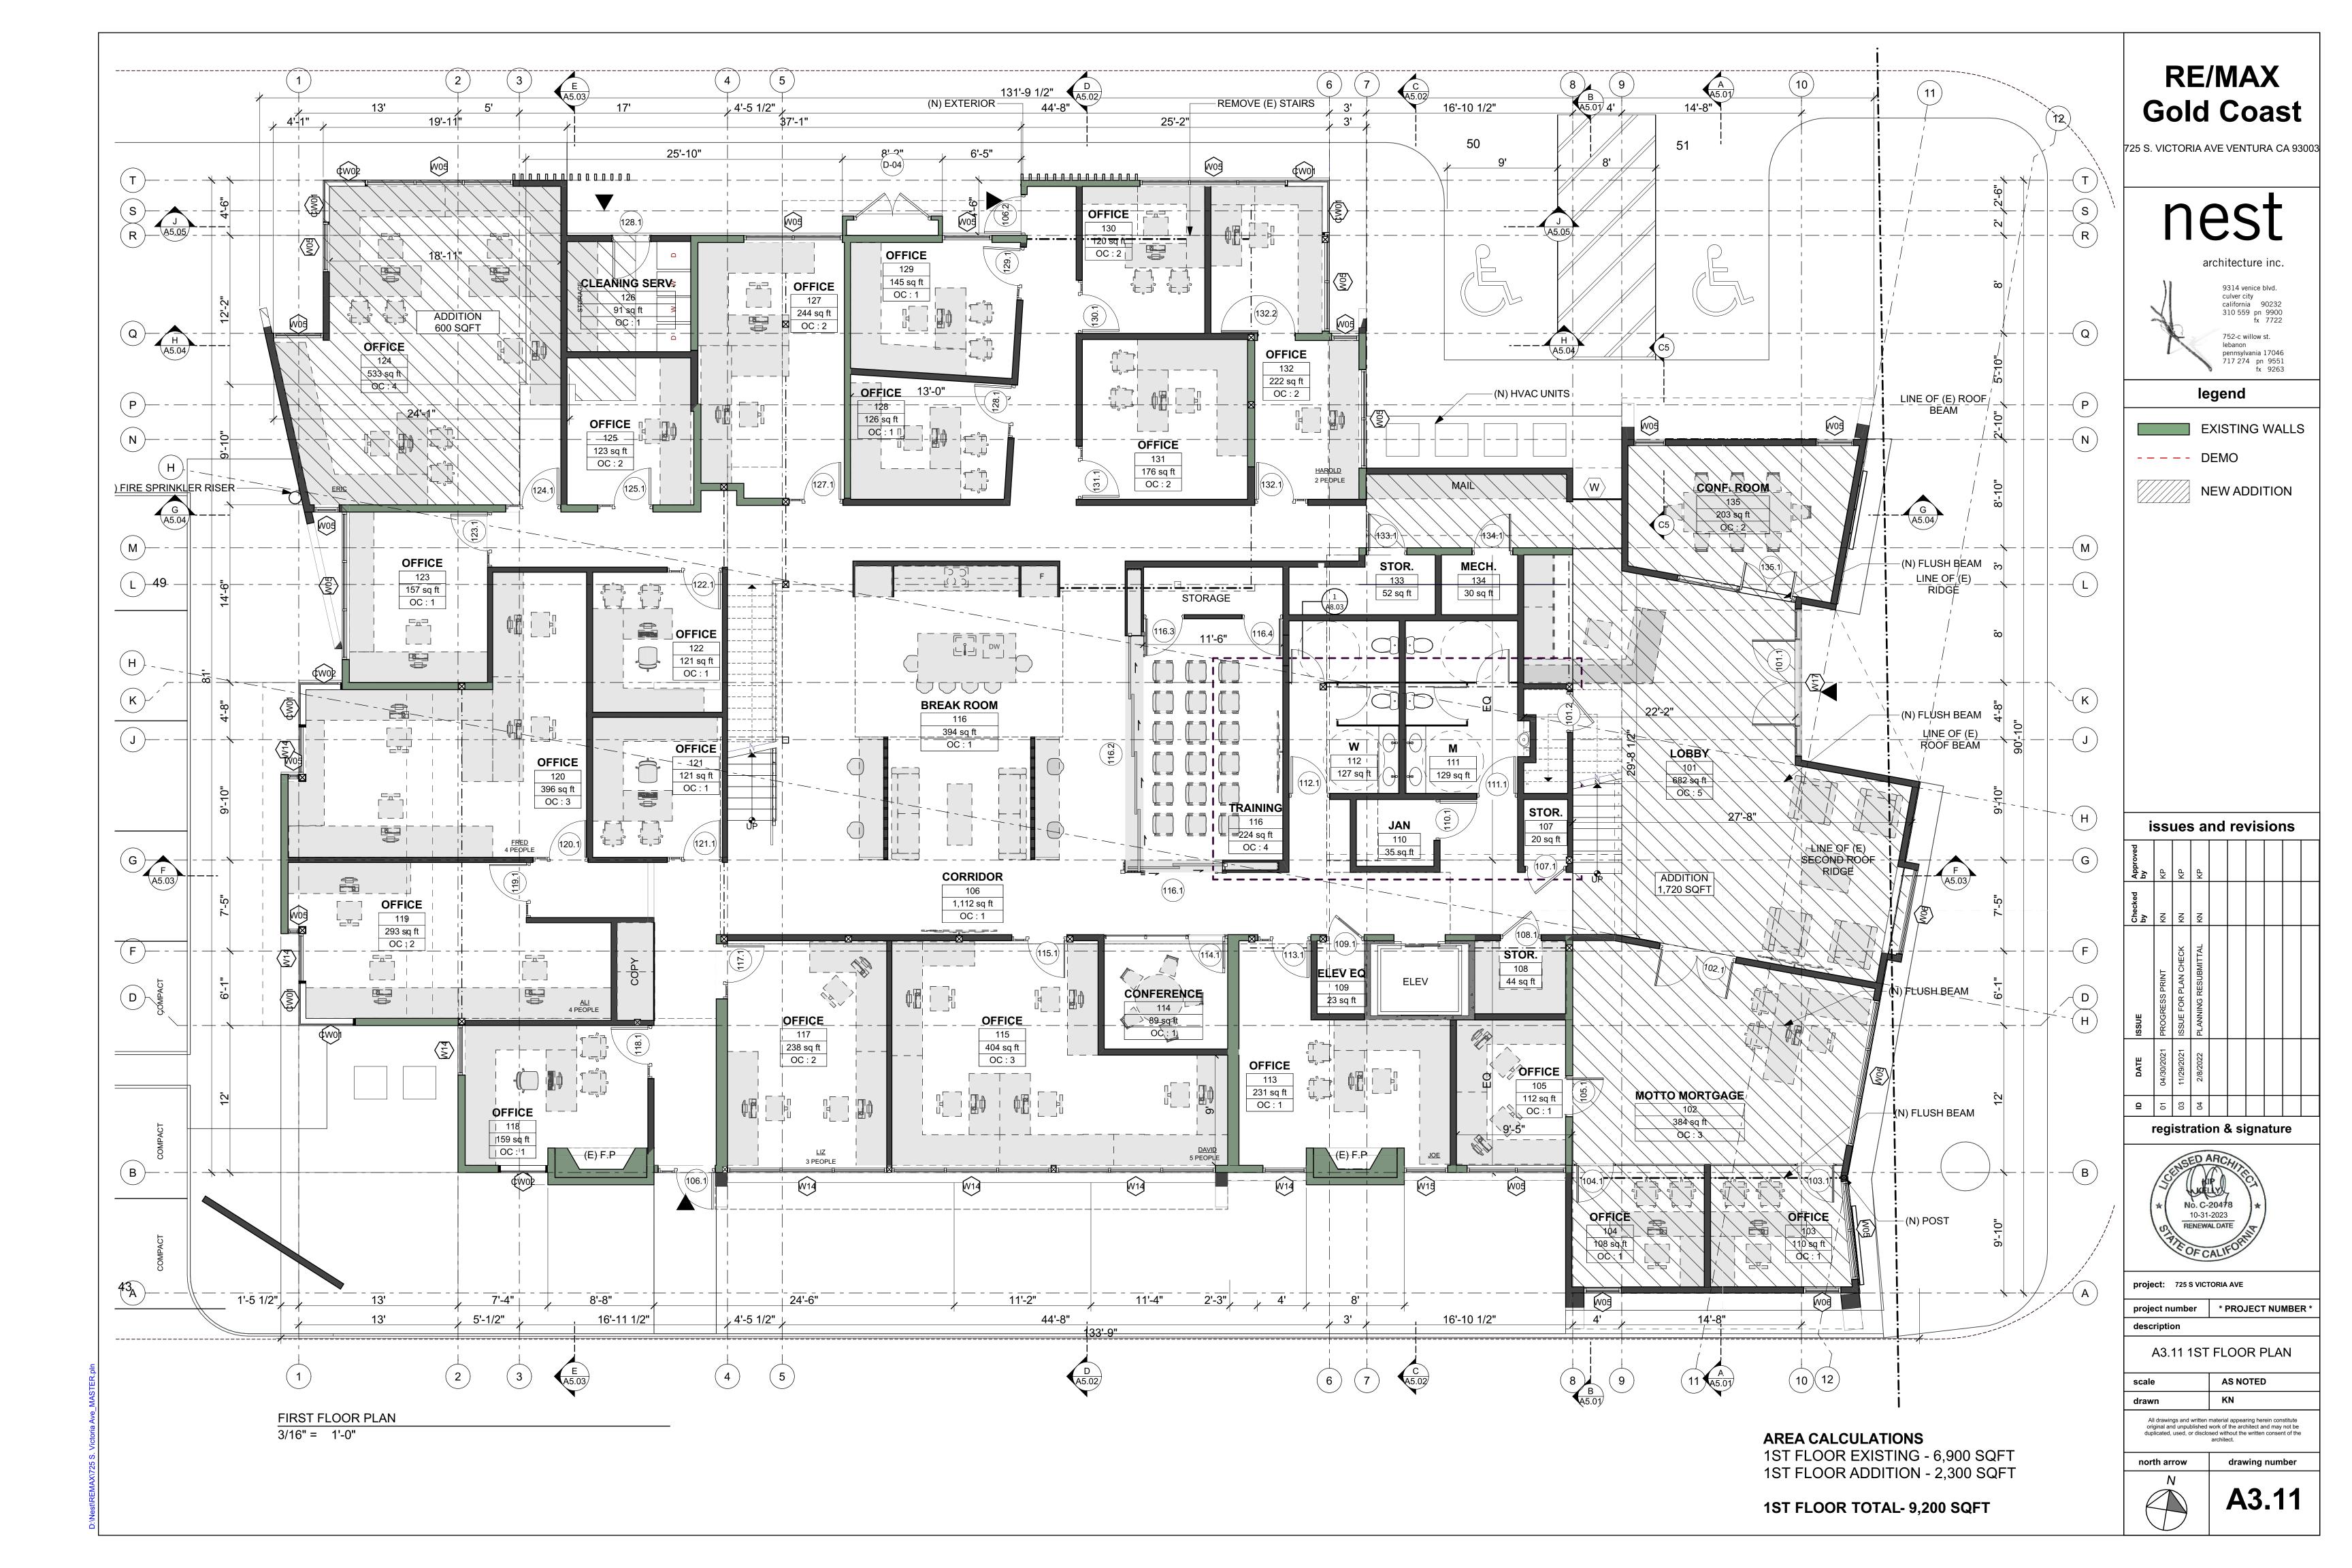








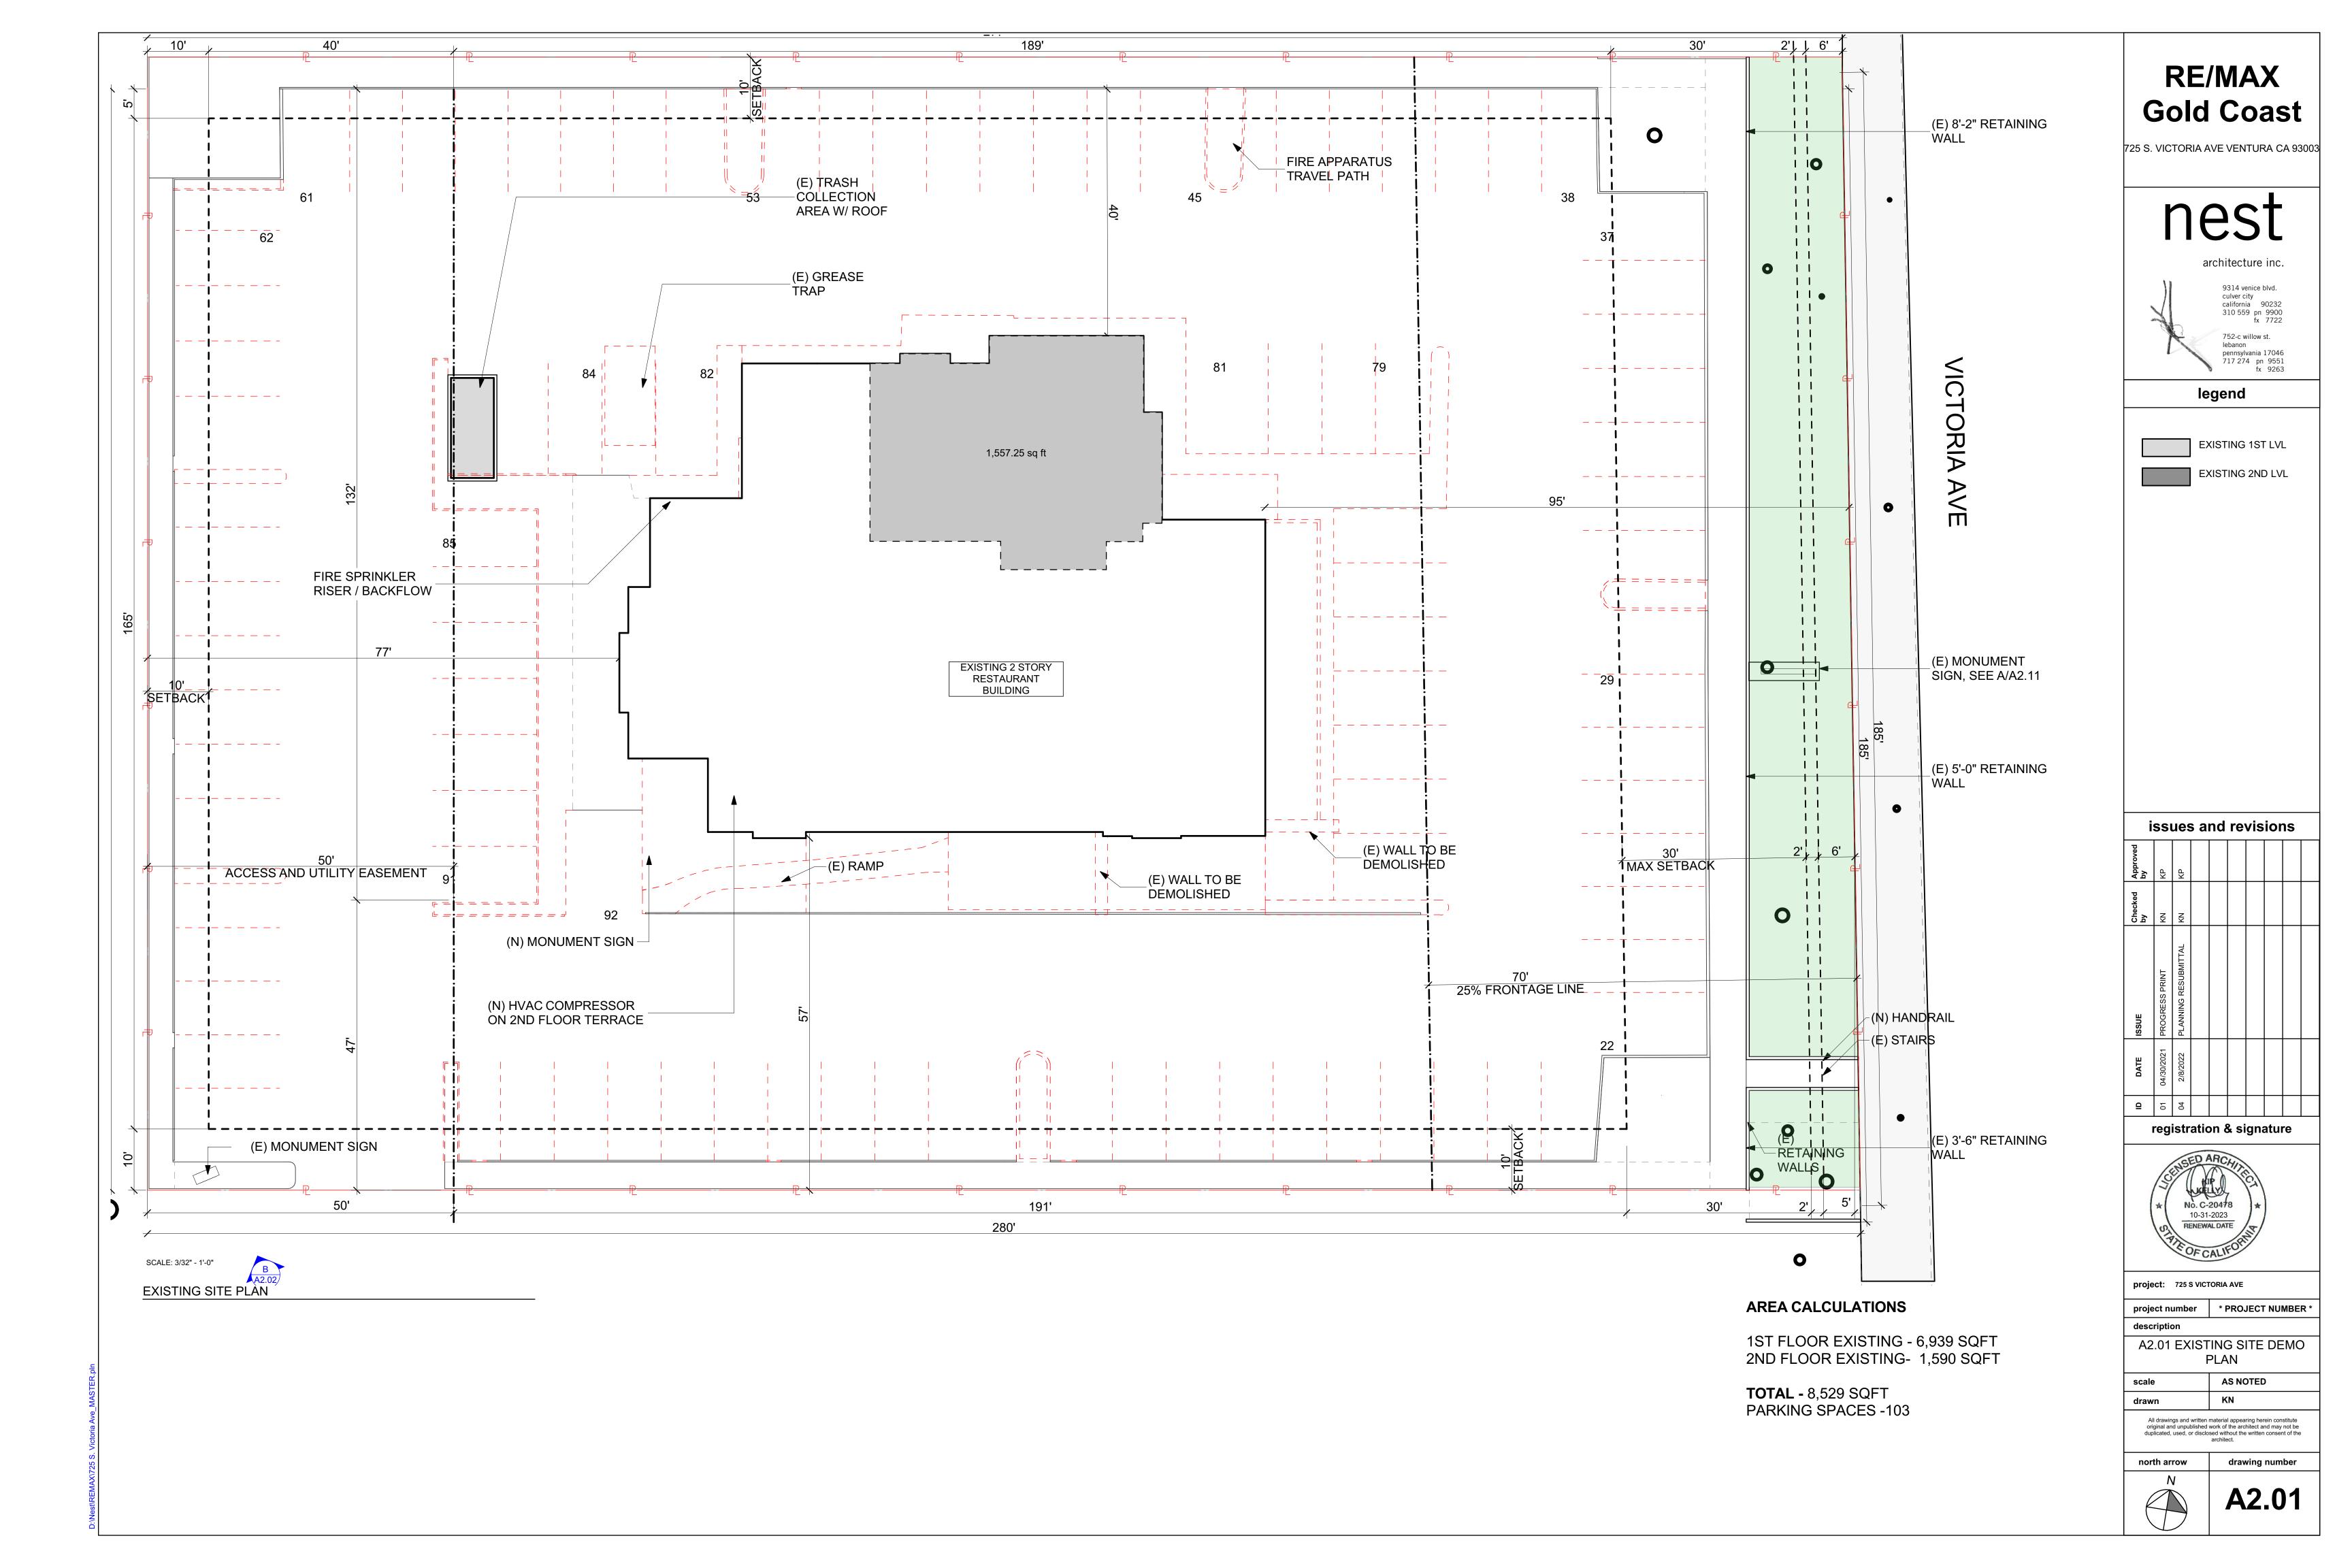


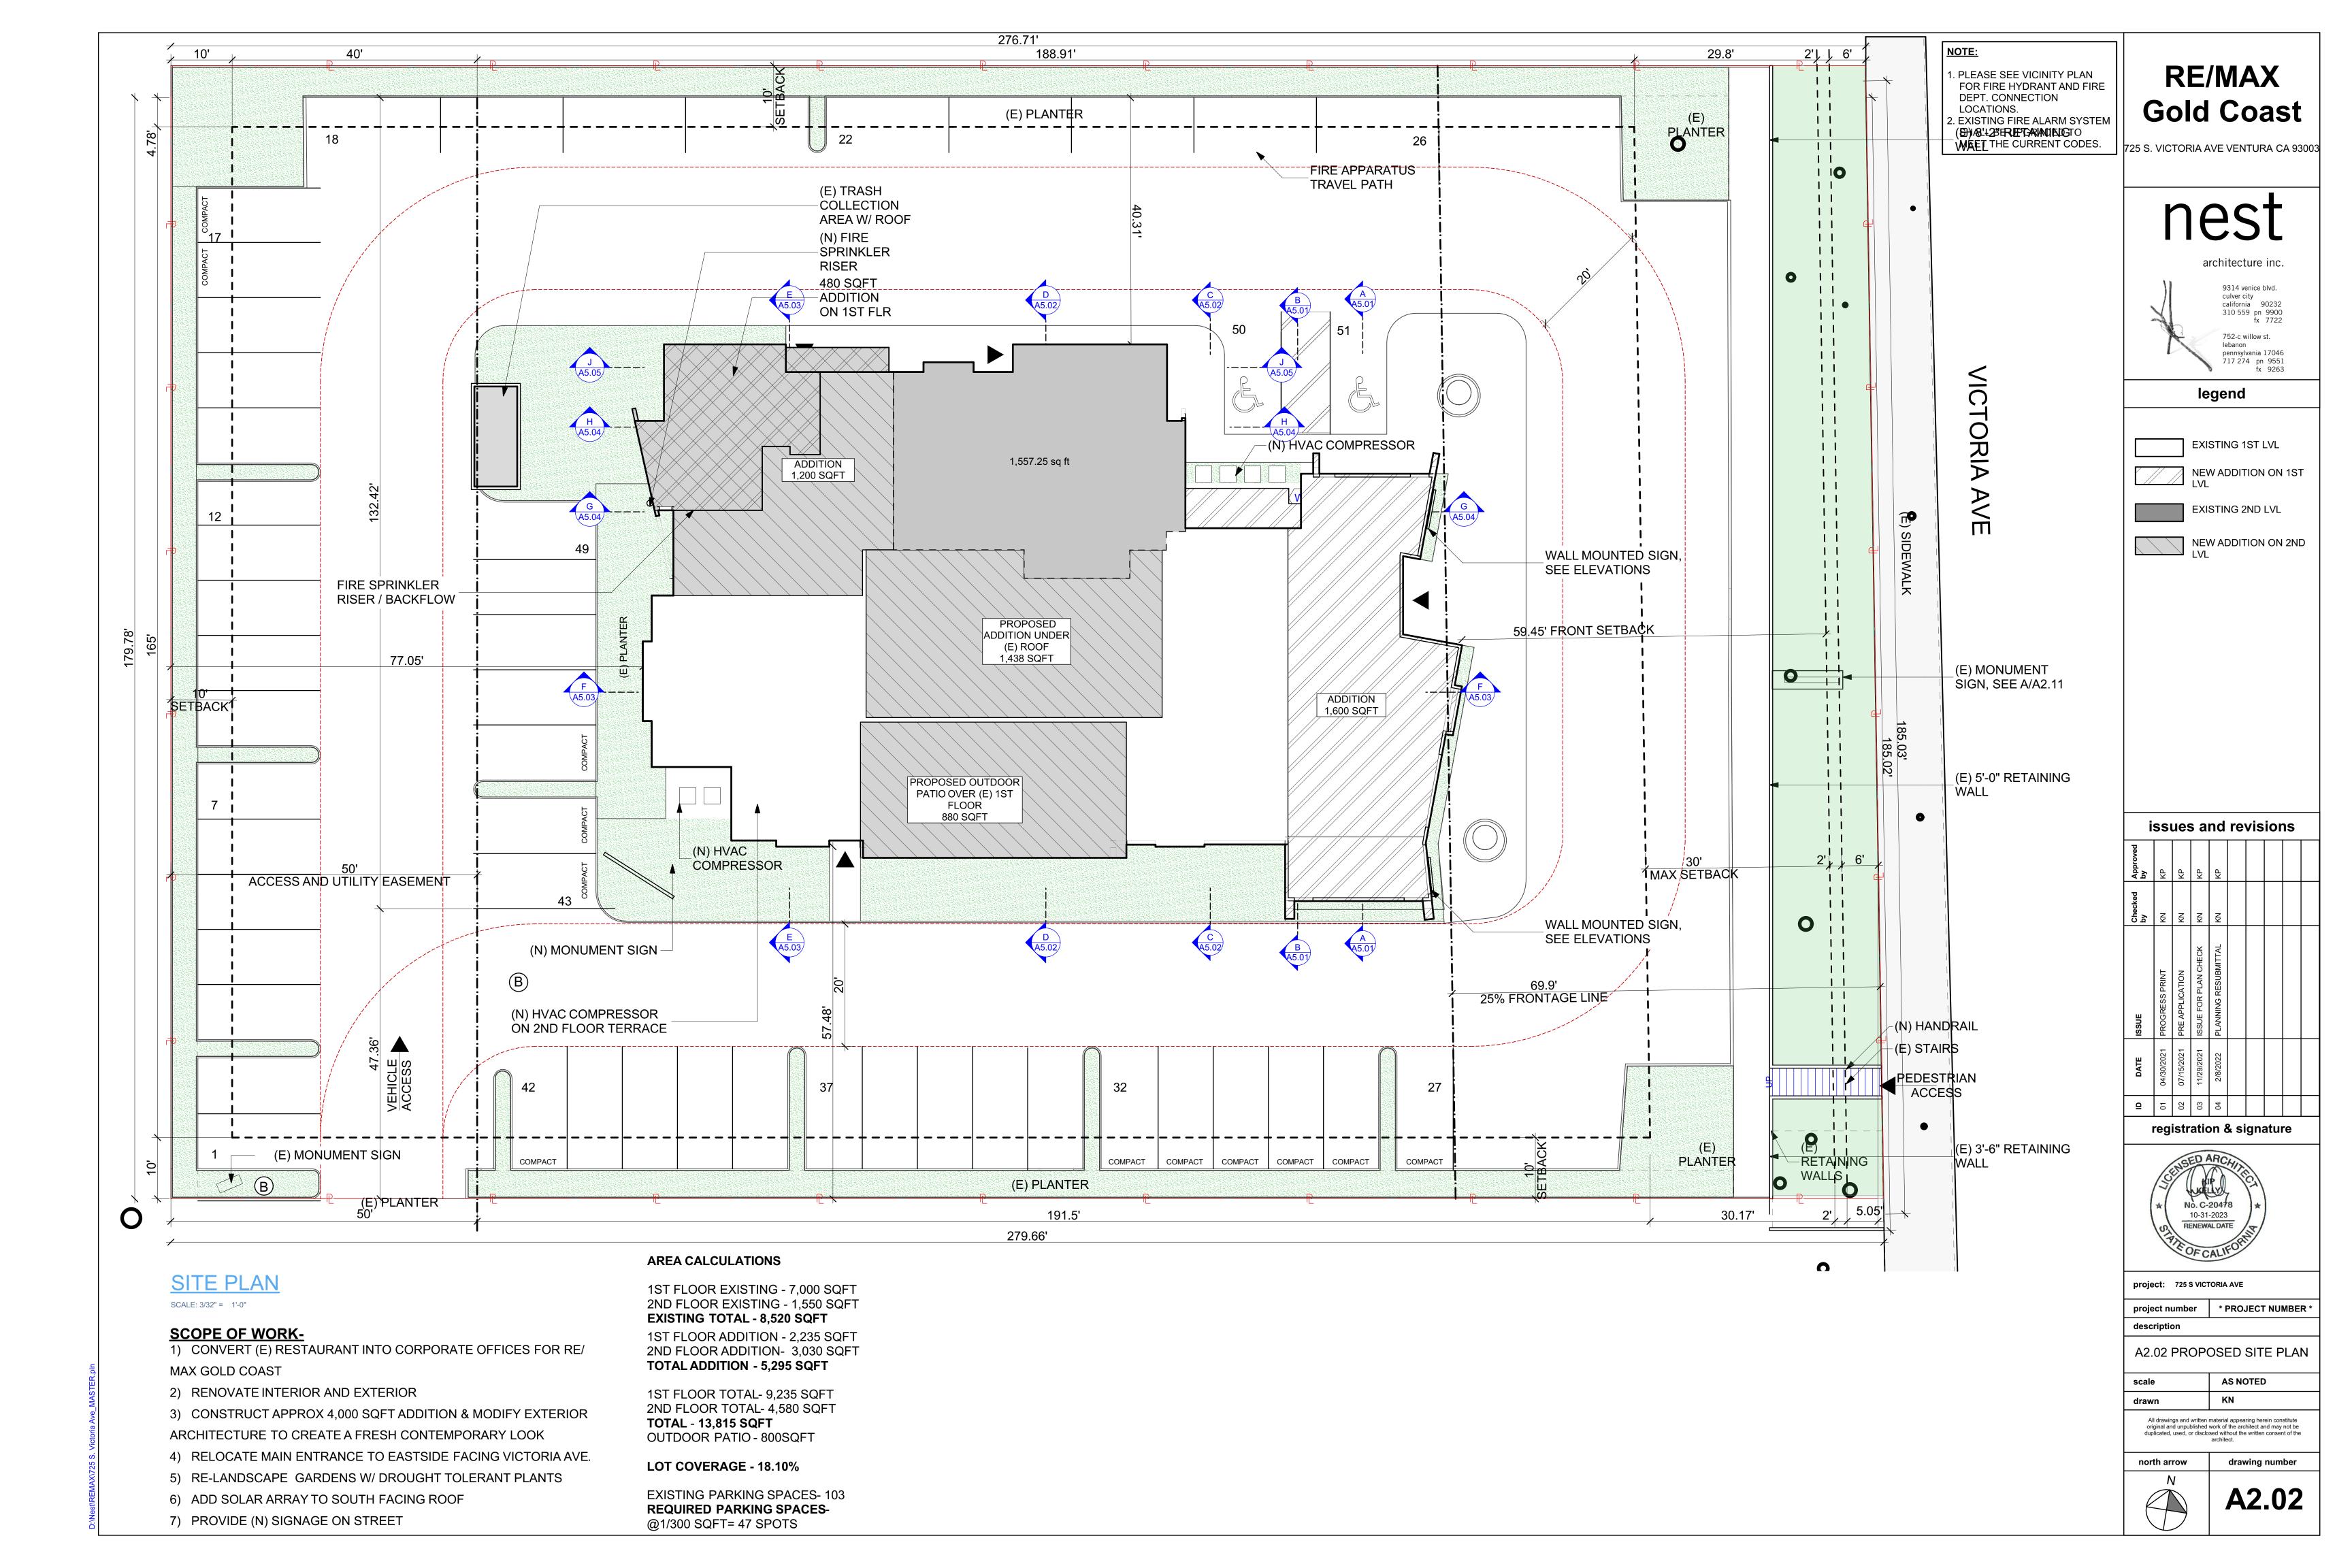


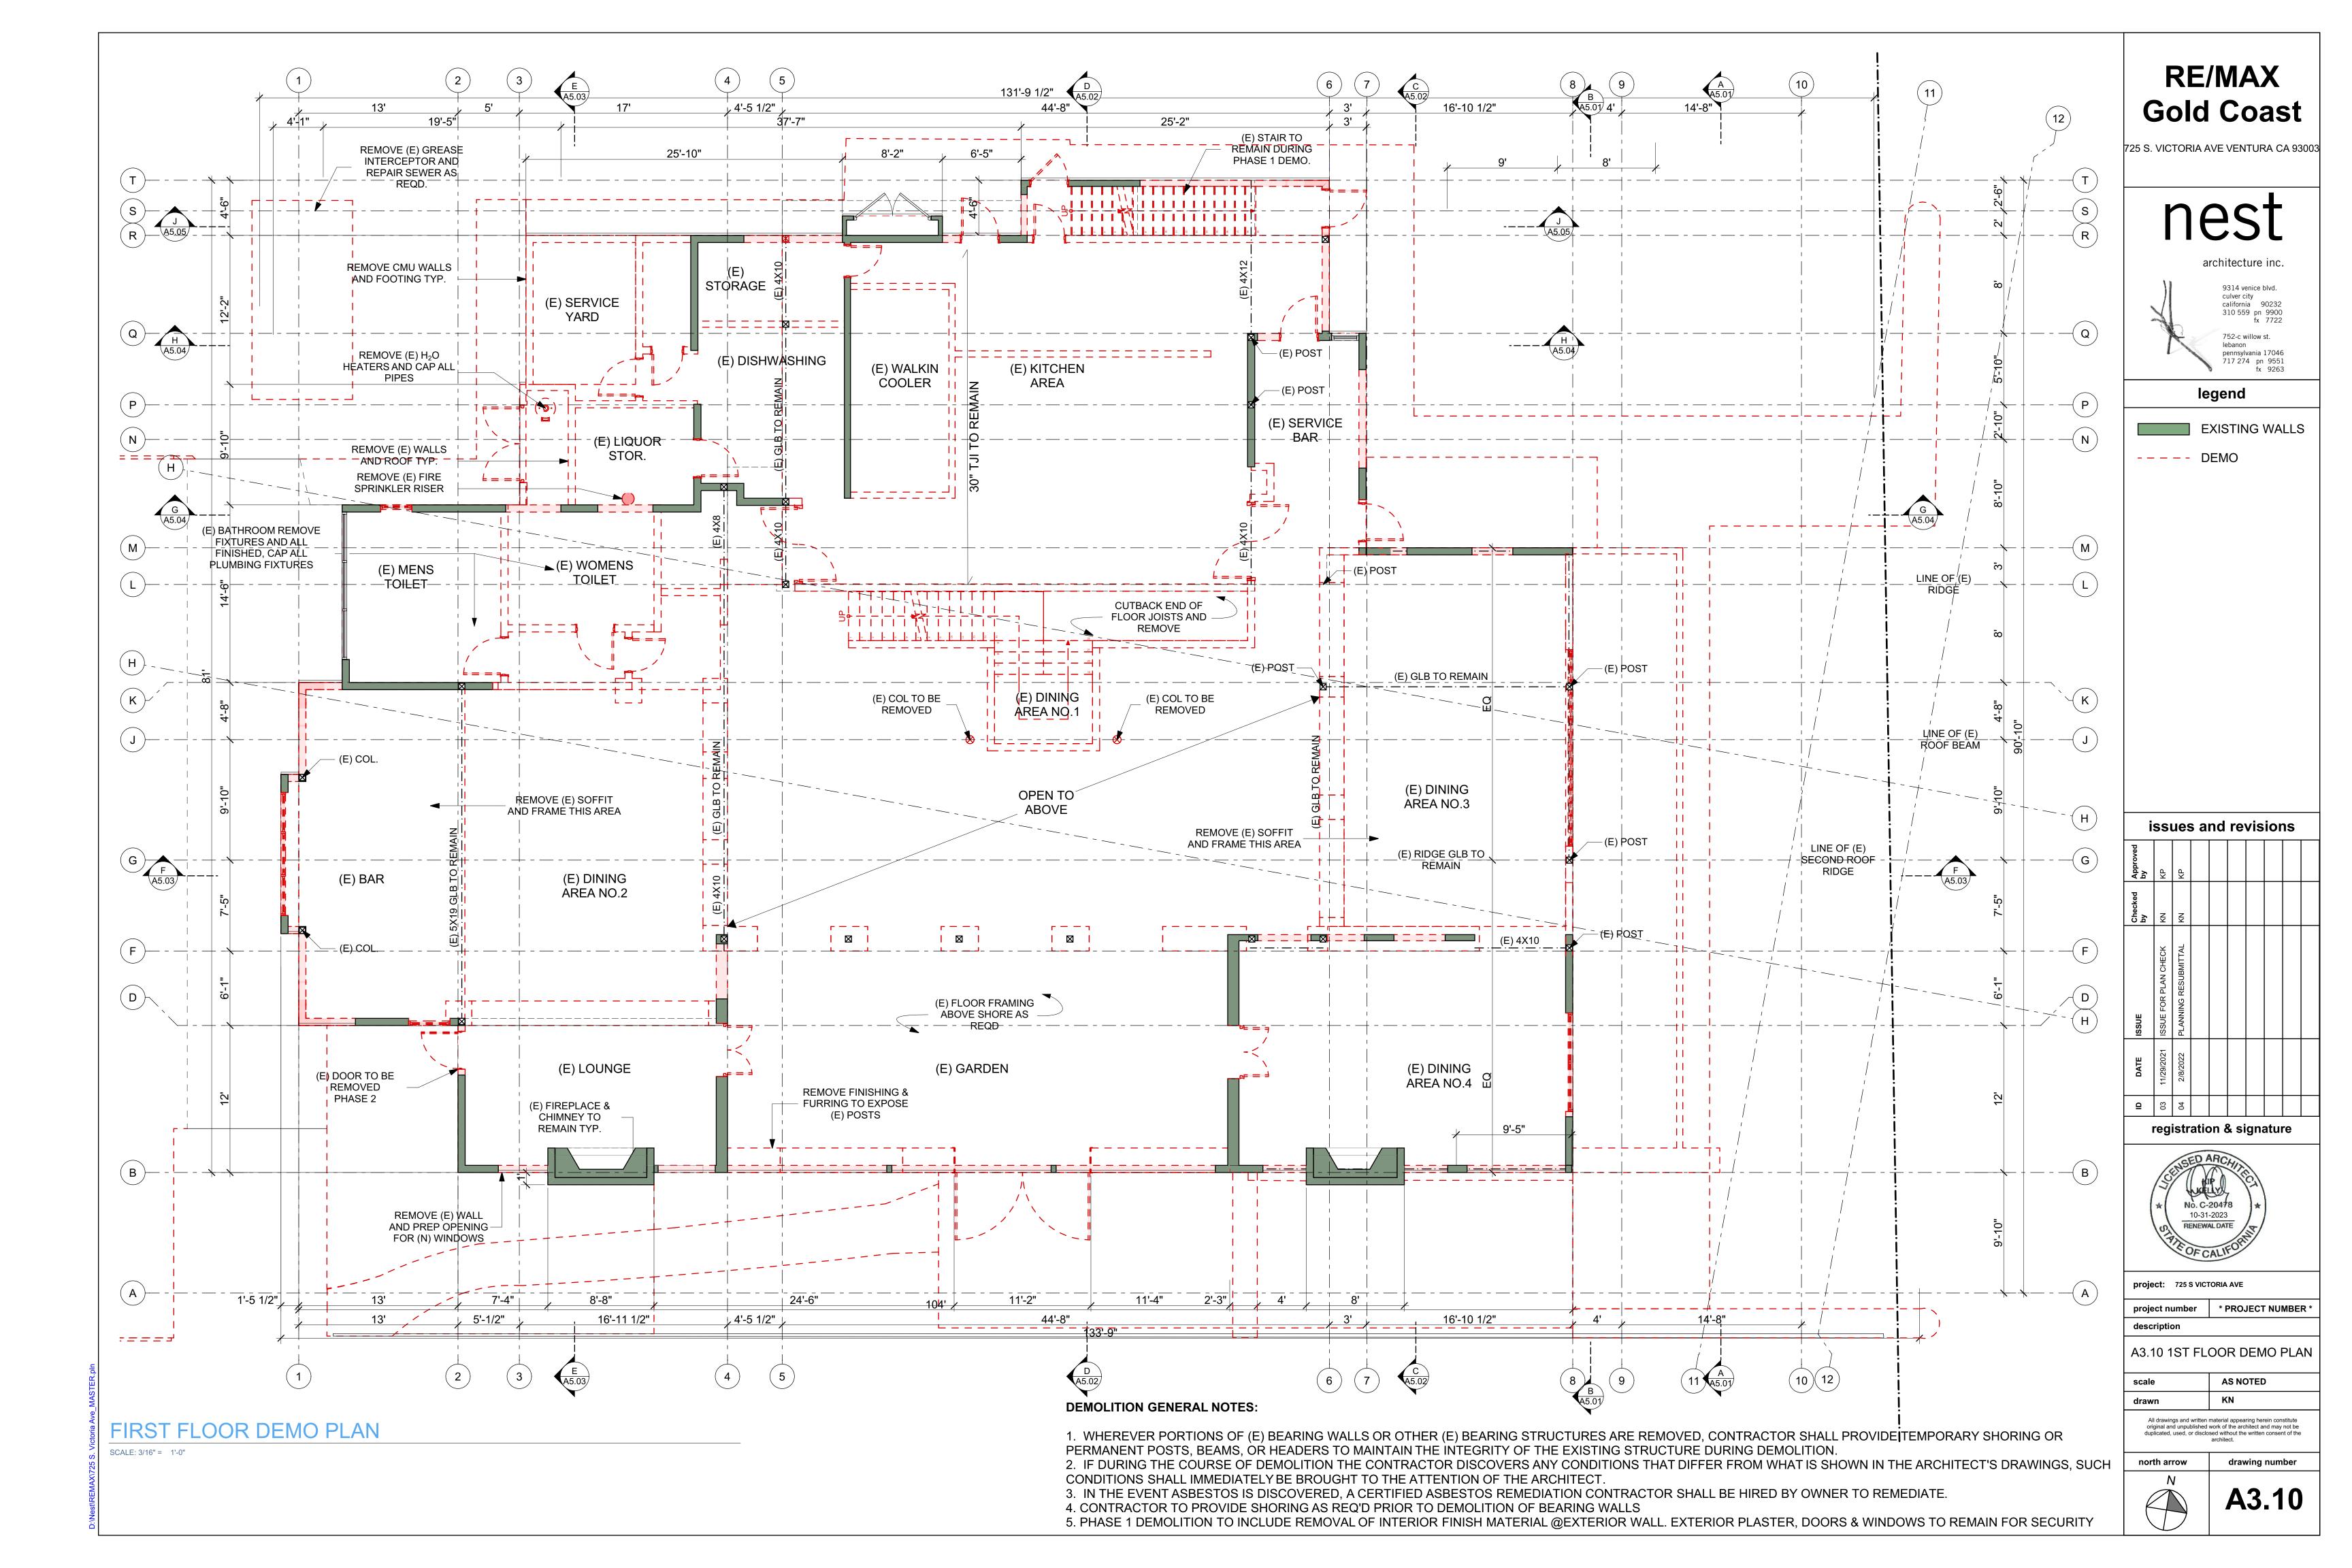

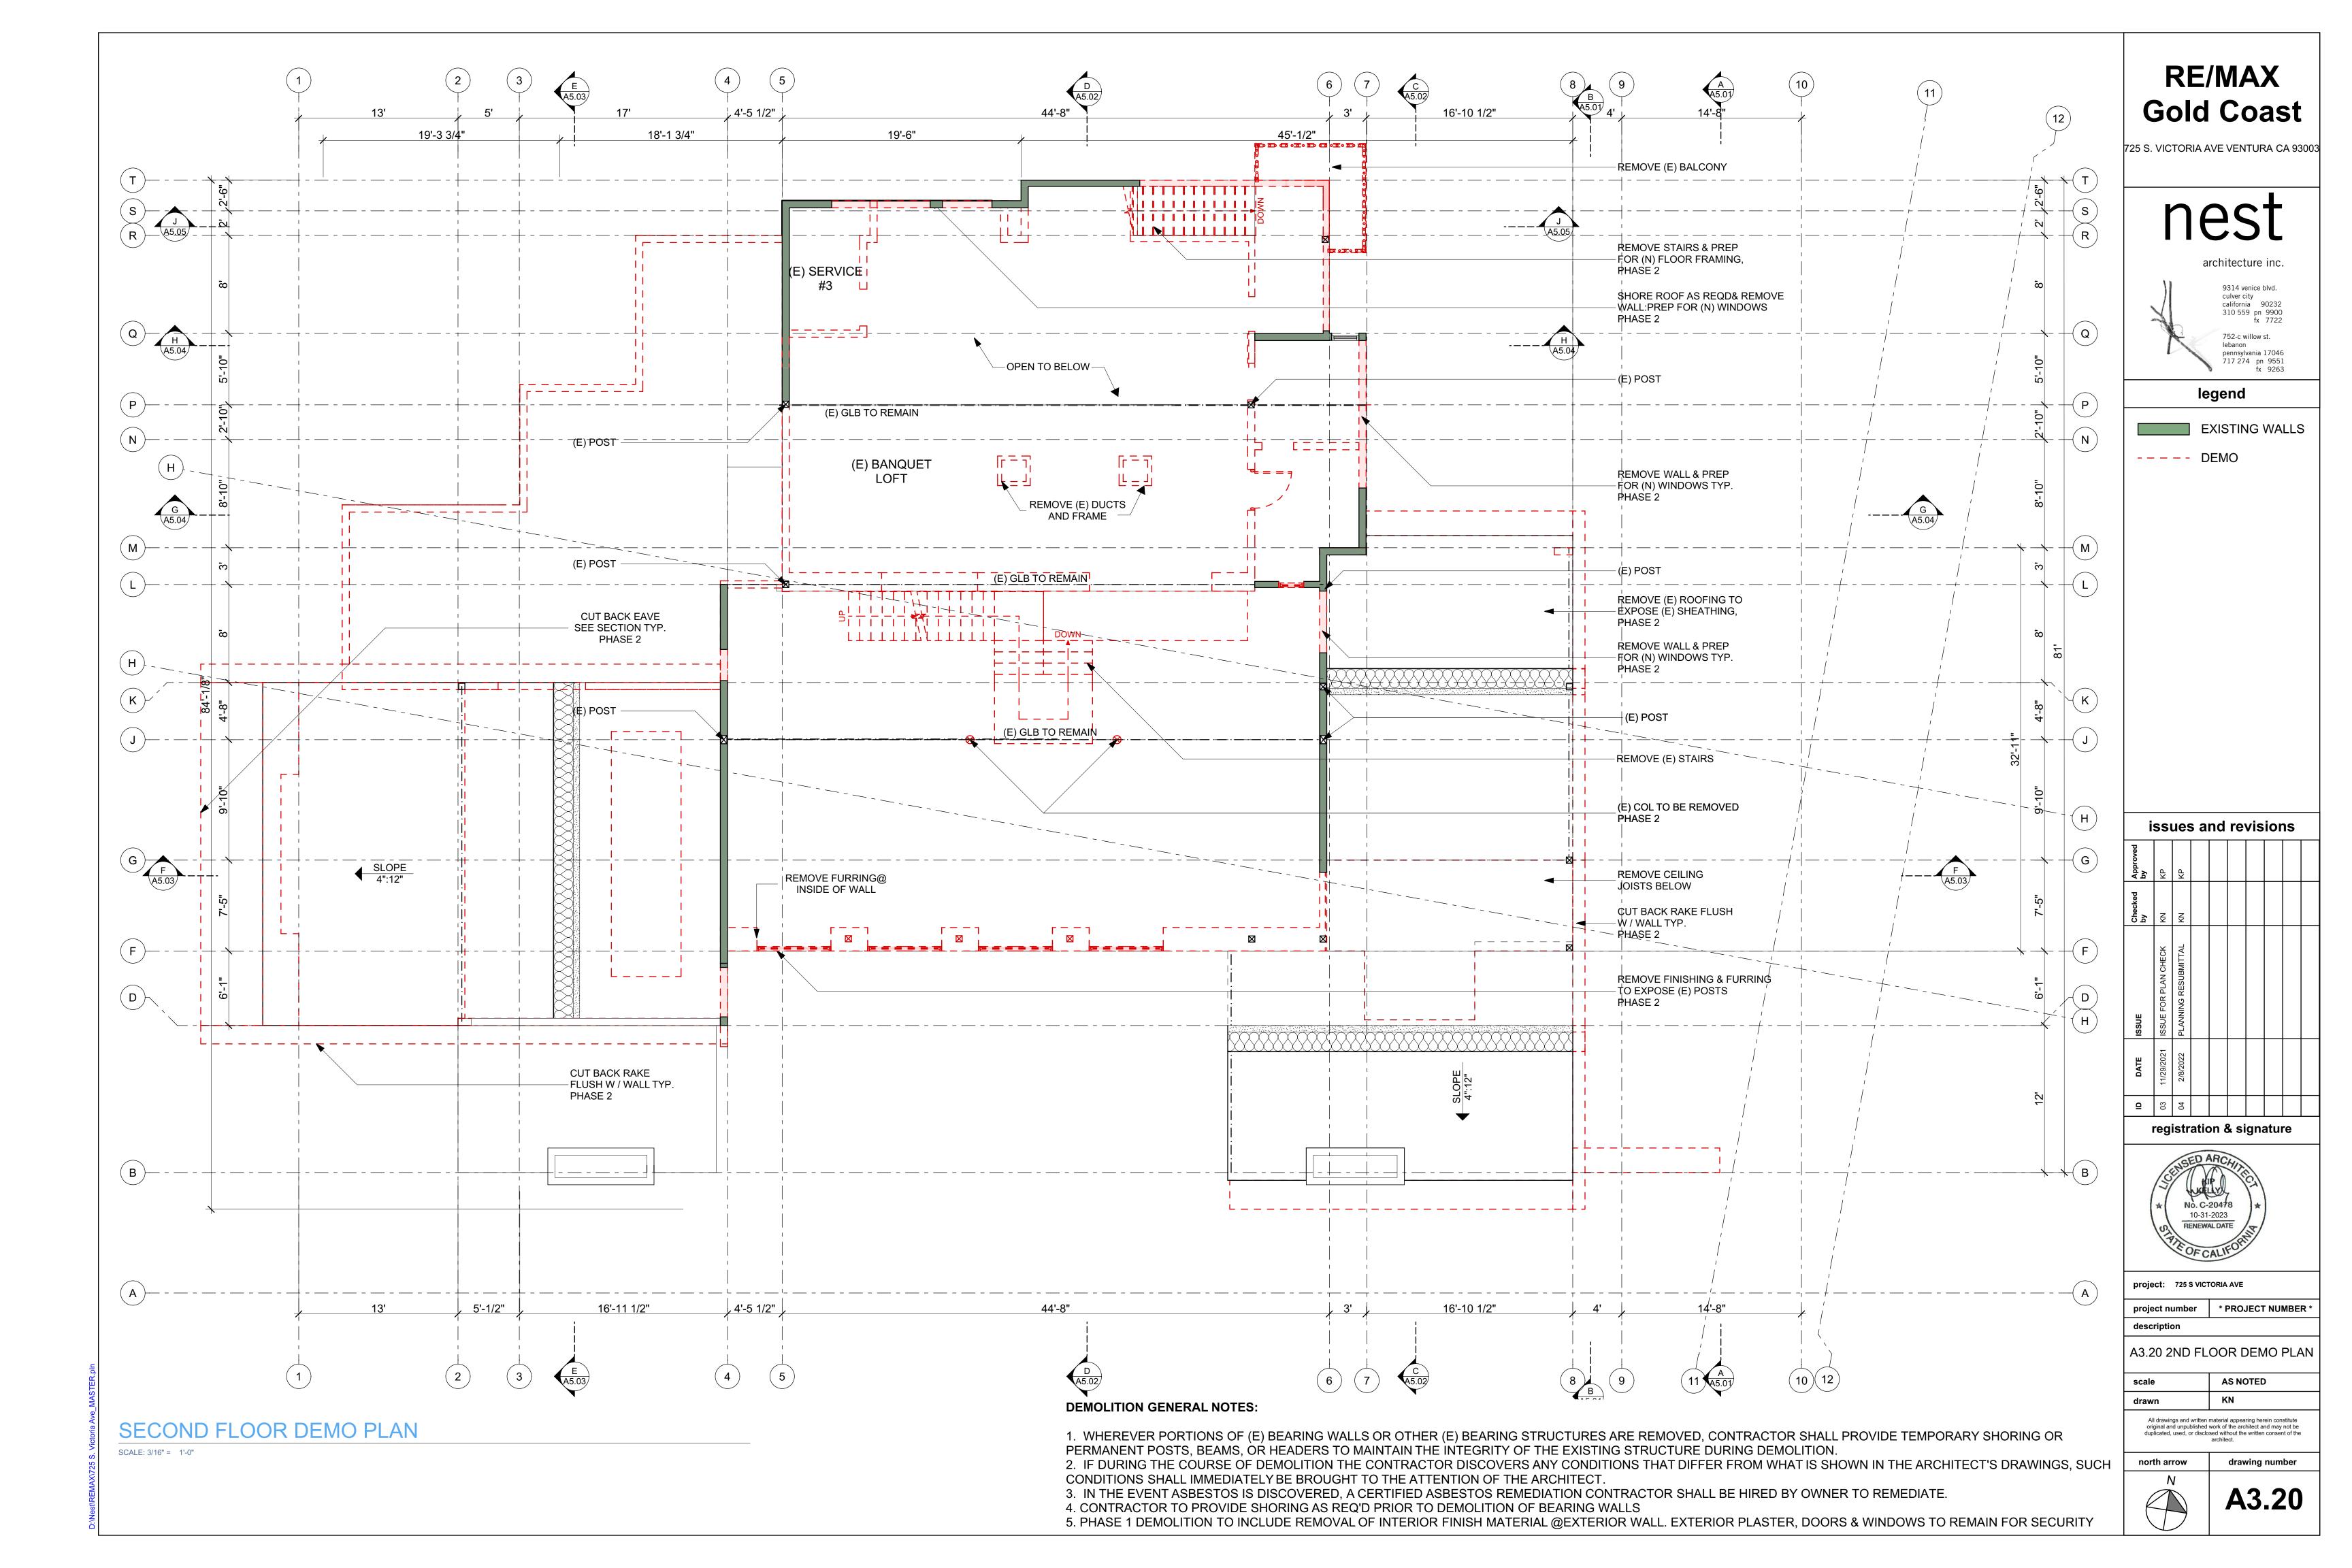

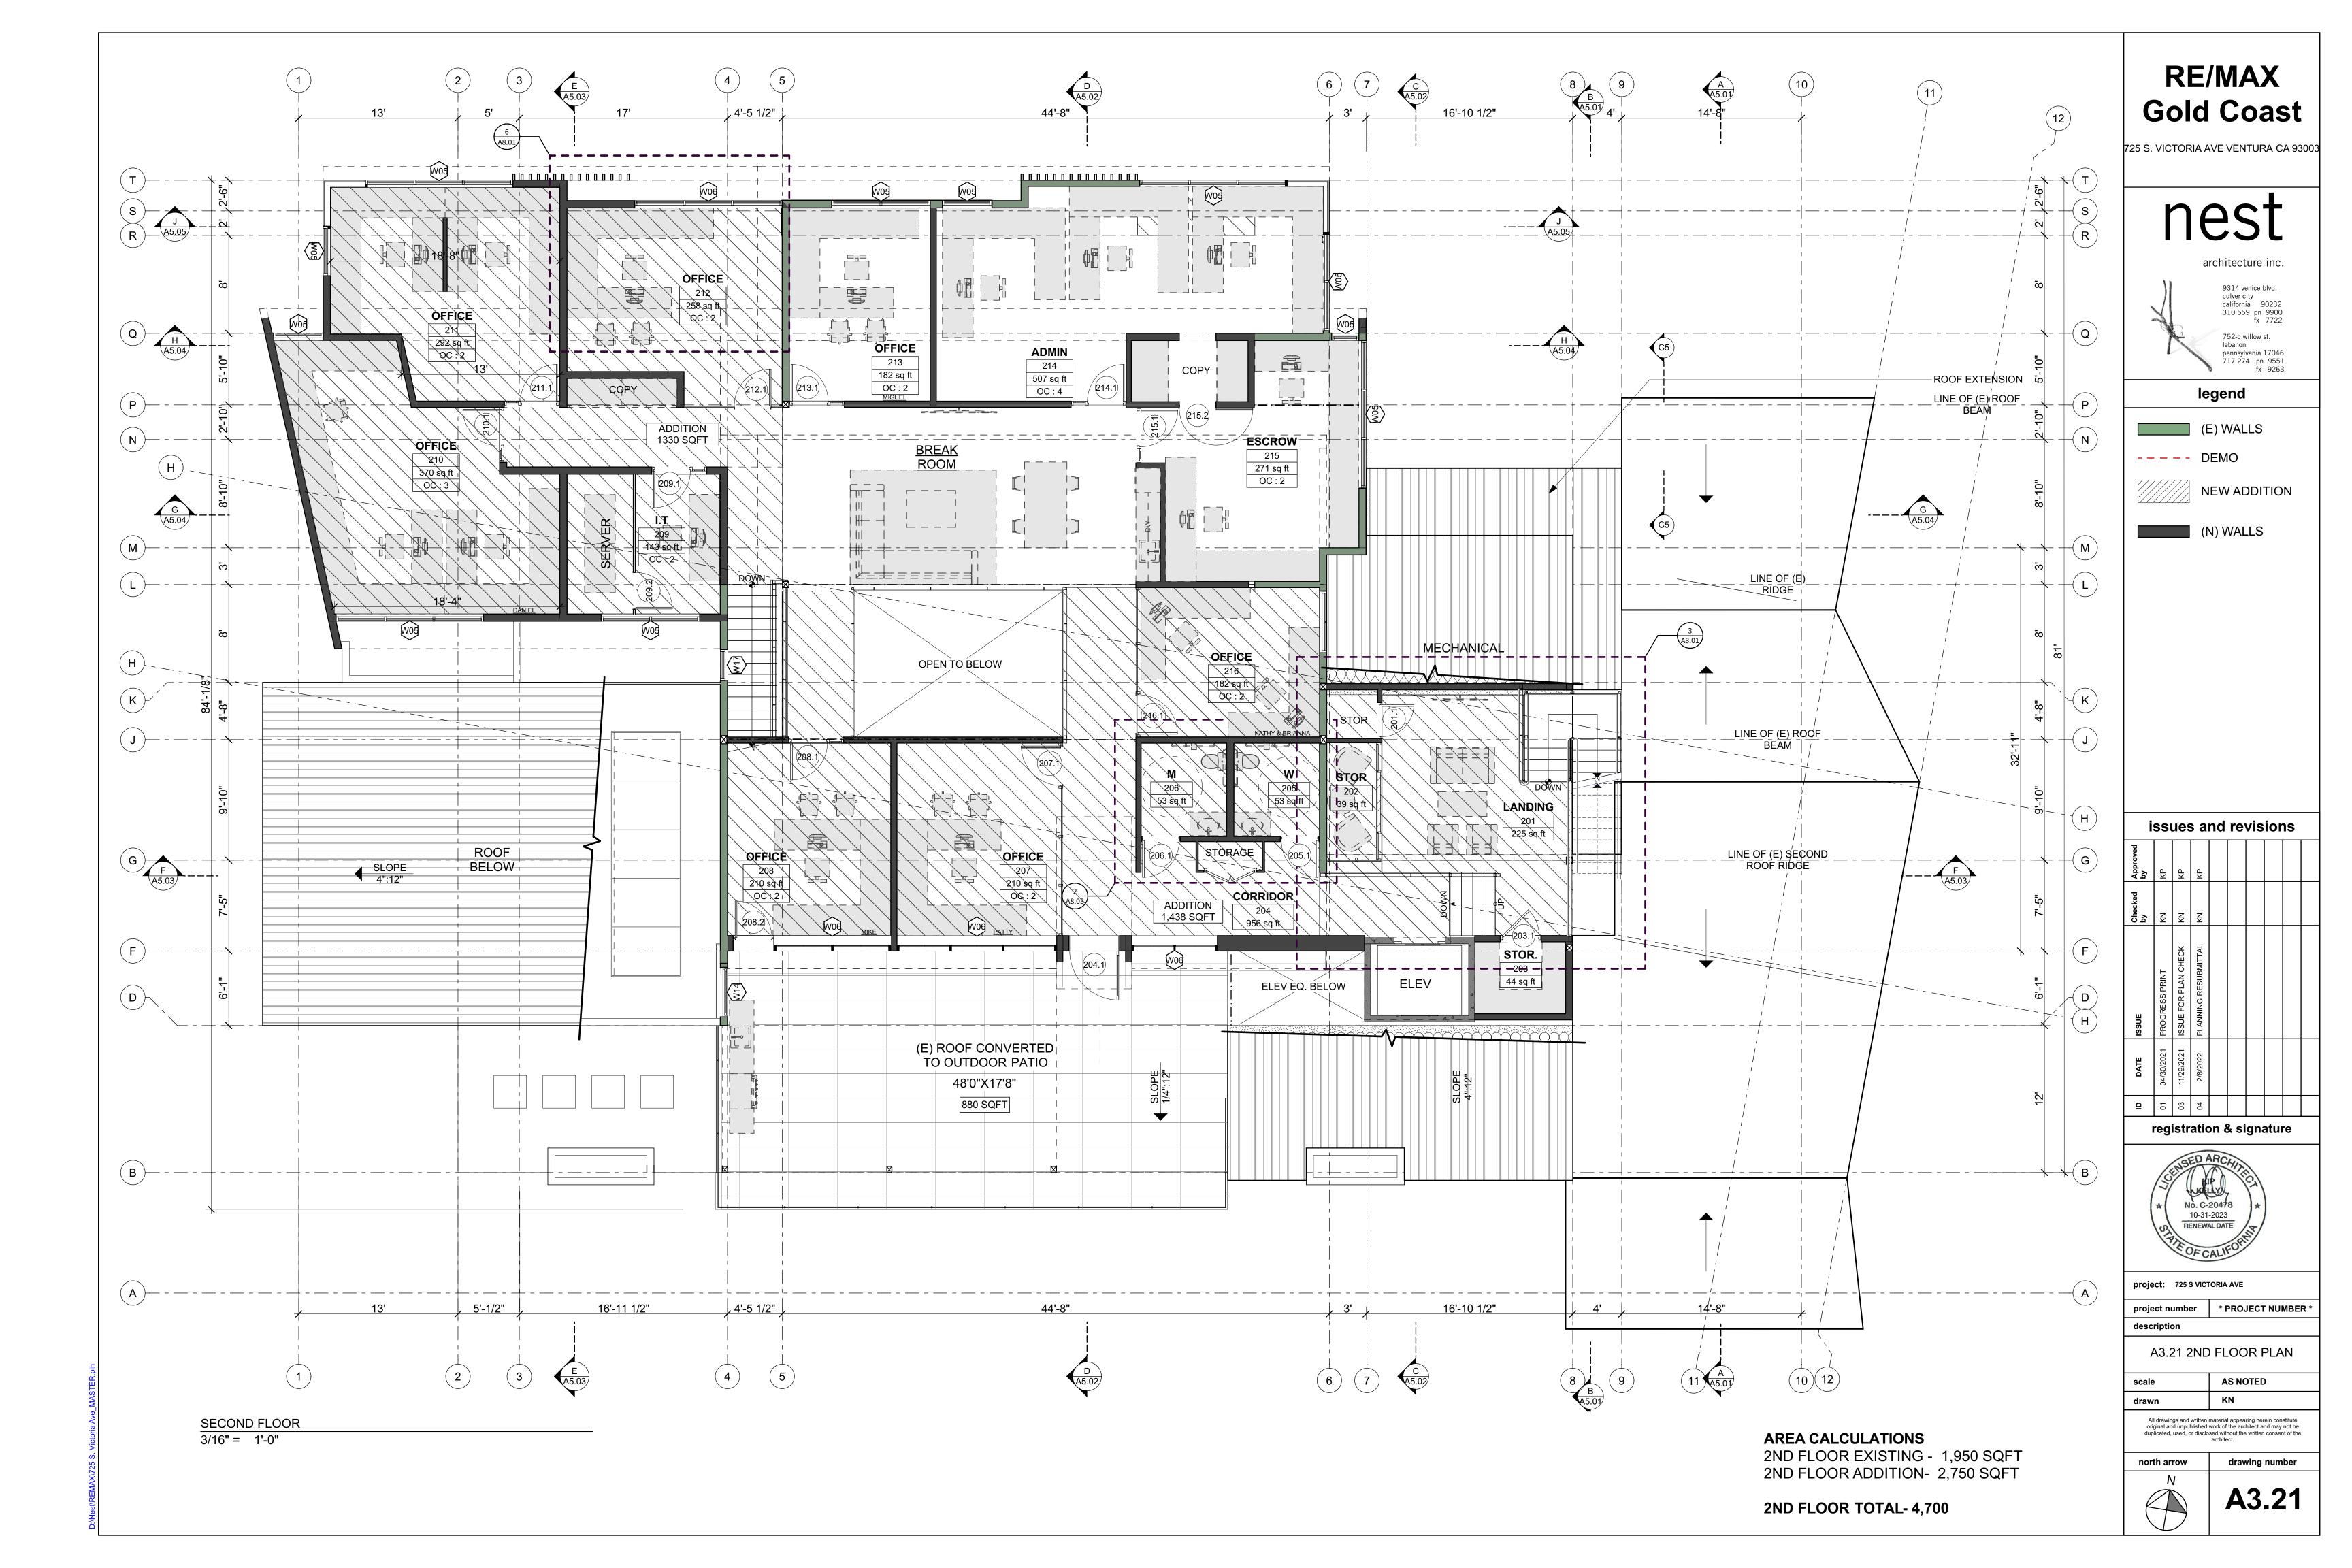

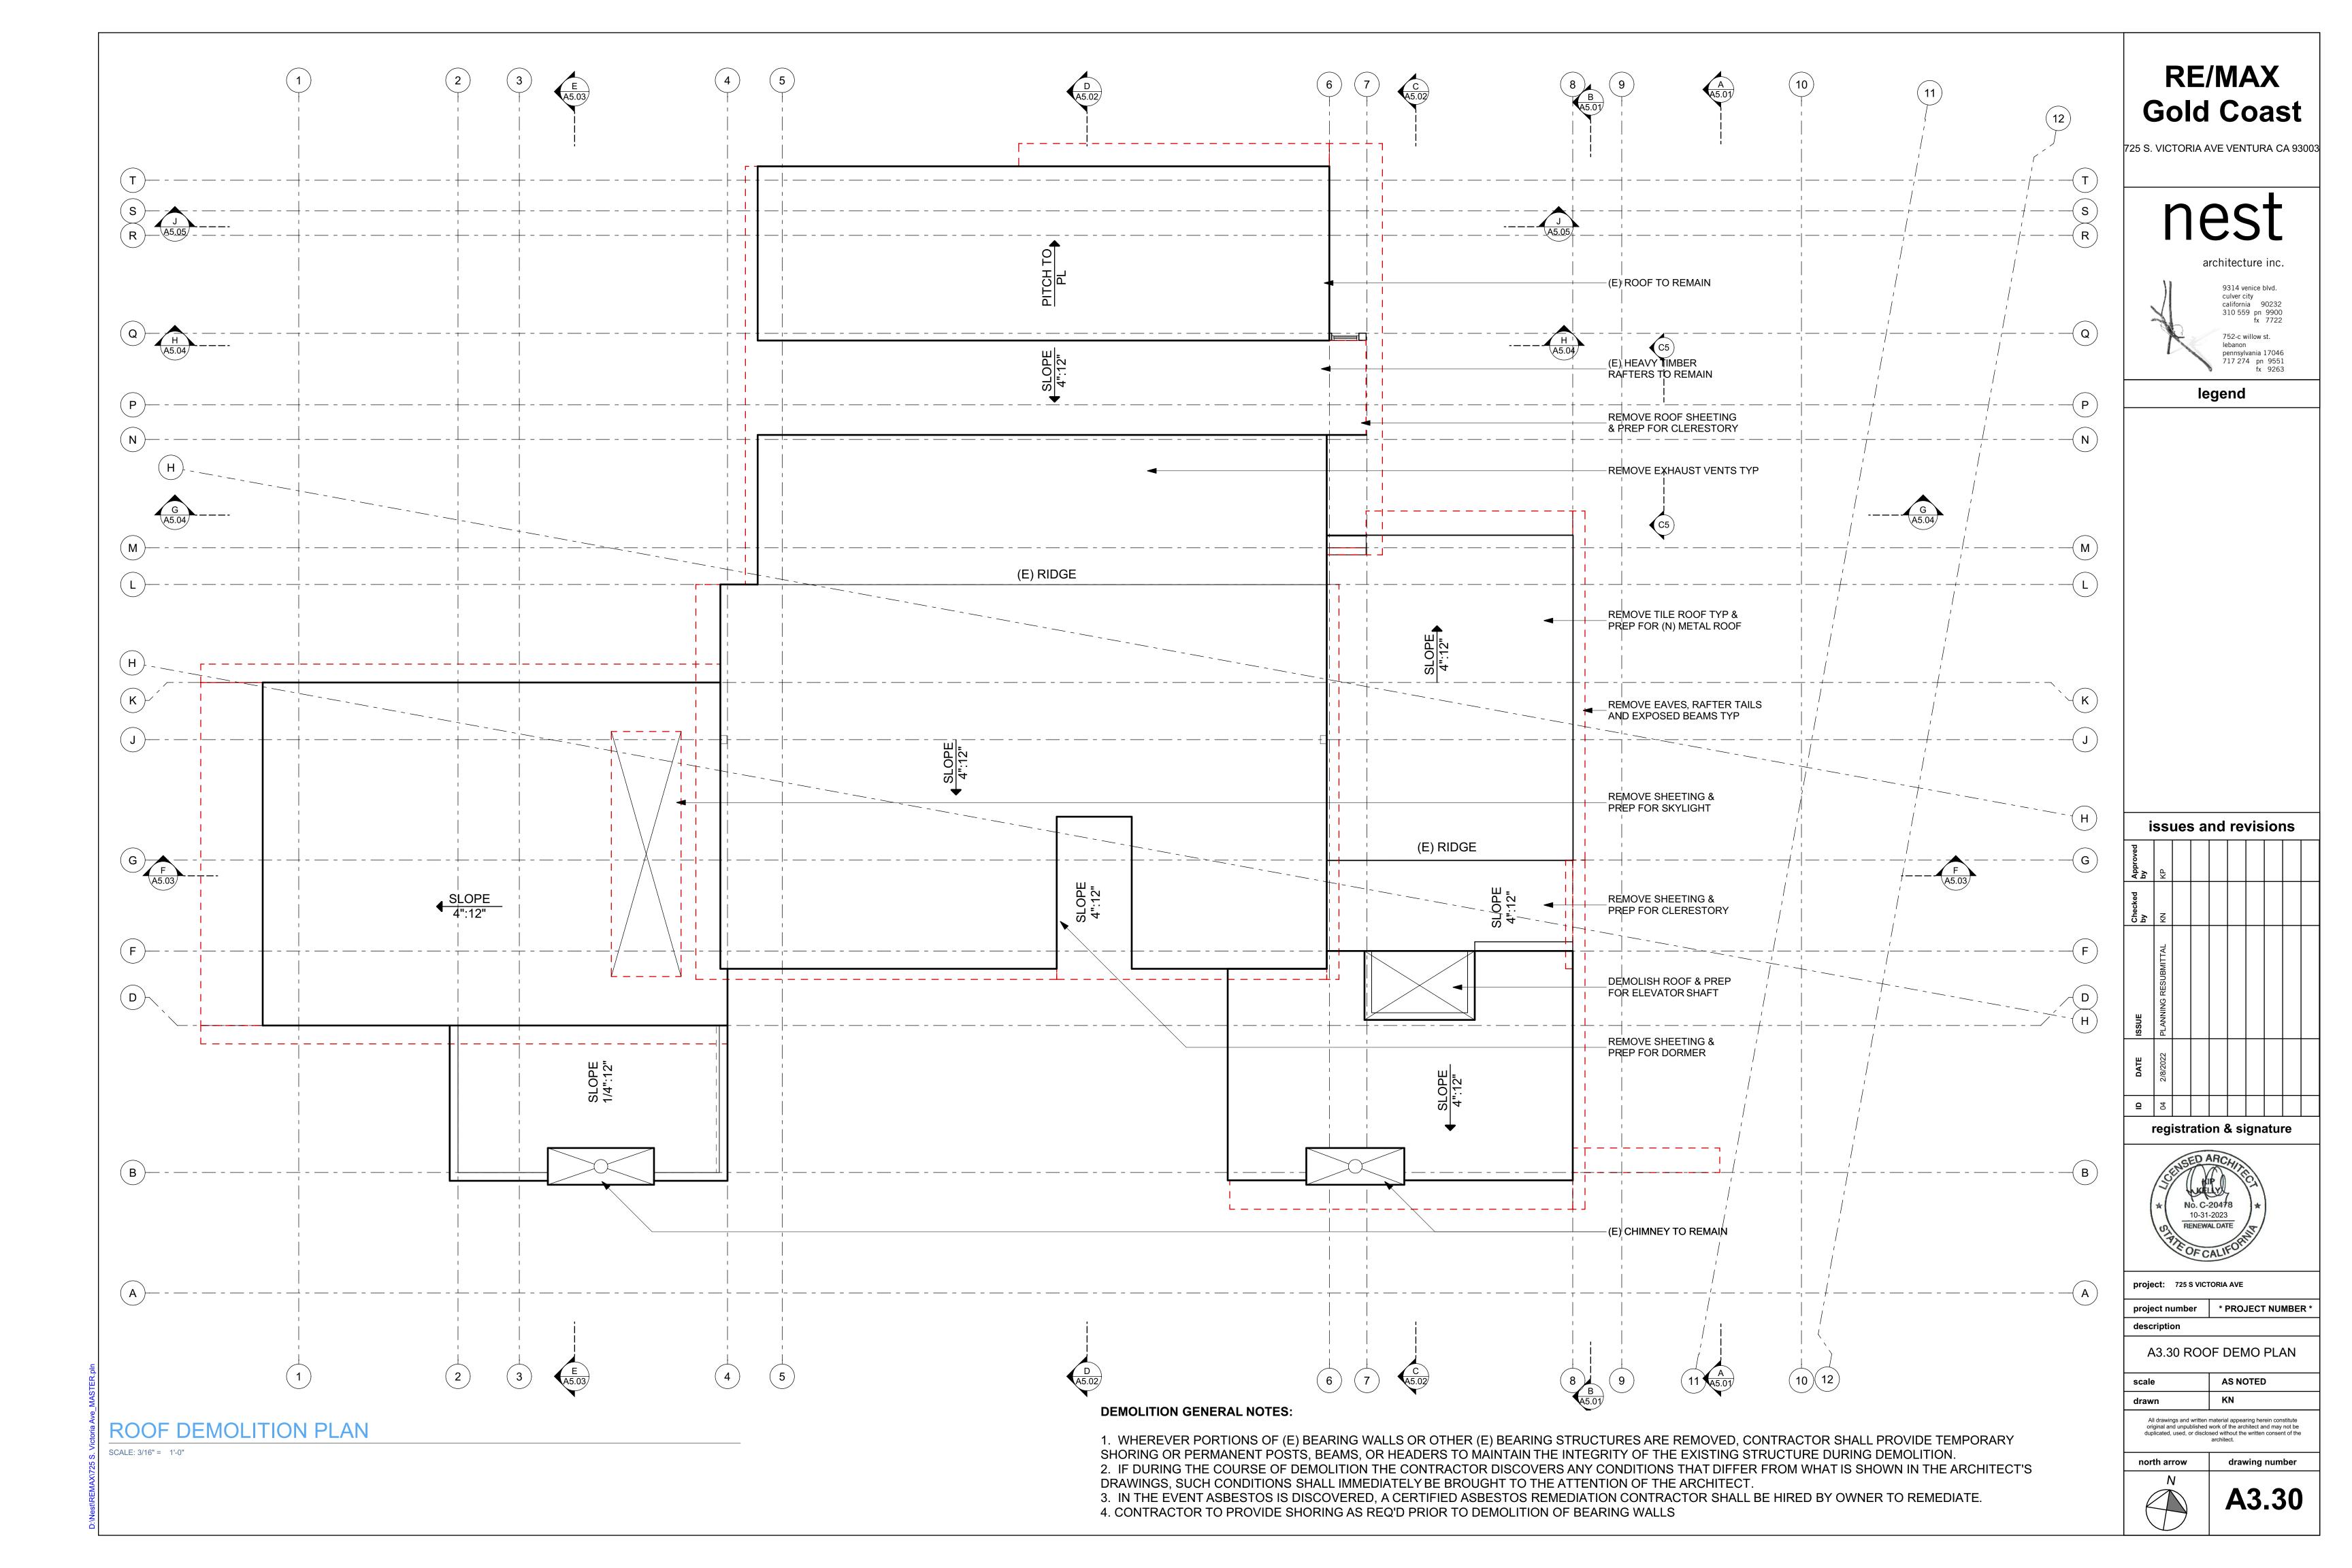

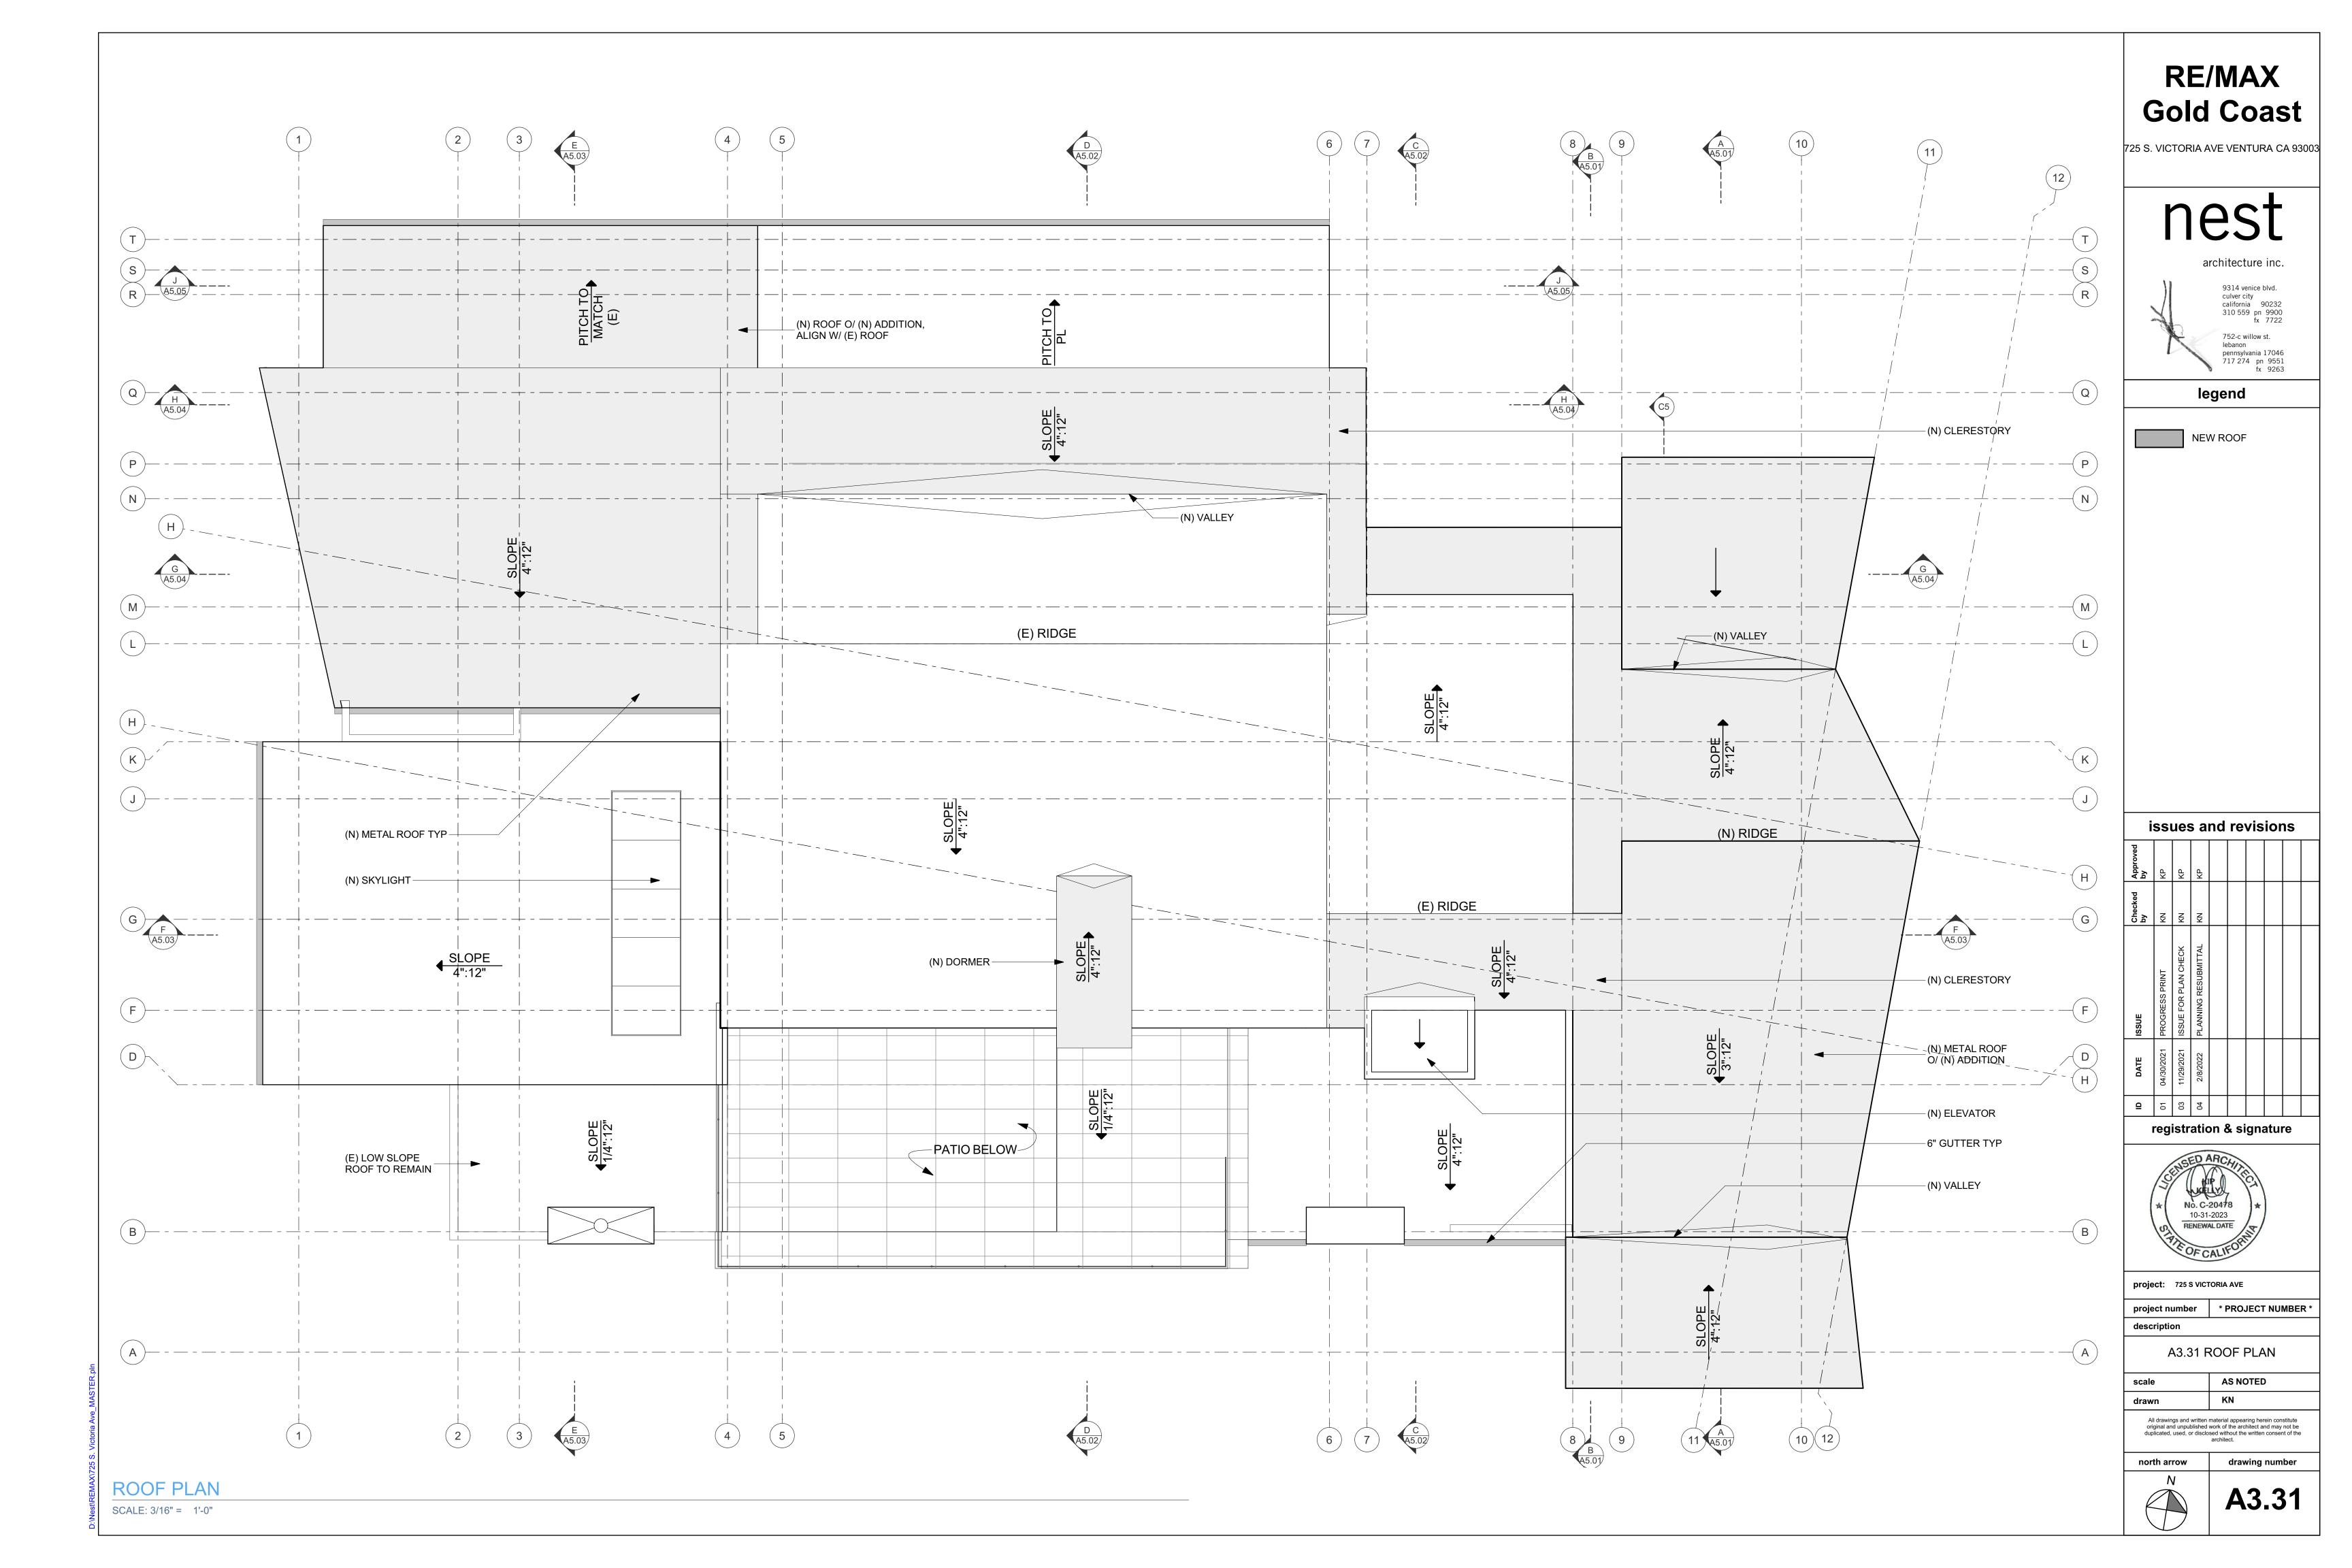



RE/MAX Gold Coast

725 S. VICTORIA AVE VENTURA CA 93003

architecture inc. 9314 venice blvd.

culver city california 90232 310 559 pn 9900 fx 7722

752-c willow st. pennsylvania 17046 717 274 pn 9551 fx 9263

legend

DARK BROWN ANODIZED

ROOF: DARK BRONZE STANDING SEAM METAL



<u>SIDING:</u> CORRUGATED METAL

MATERIAL LEGEND

GREEN WALL: RED TRUMPET VINE, SEE

EXTERIOR CEMENT PLASTER SMOOTH FINISH, COLOR:GRAY

LANDSCAPE PLANS

EXTERIOR CEMENT

VERTICAL SCREEN: STAINED DOUGLAS FIR

WINDOW & DOOR FRAMES:

<u>GLASS:</u> CLEAR TYP.

PLASTER W/ REVEALS




PERFORATED METAL
O/ STEEL STRUCTURE



<u>CANOPY:</u> TENSILE FABRIC

WEST ELEVATION

SCALE: 3/16" = 1'-0"

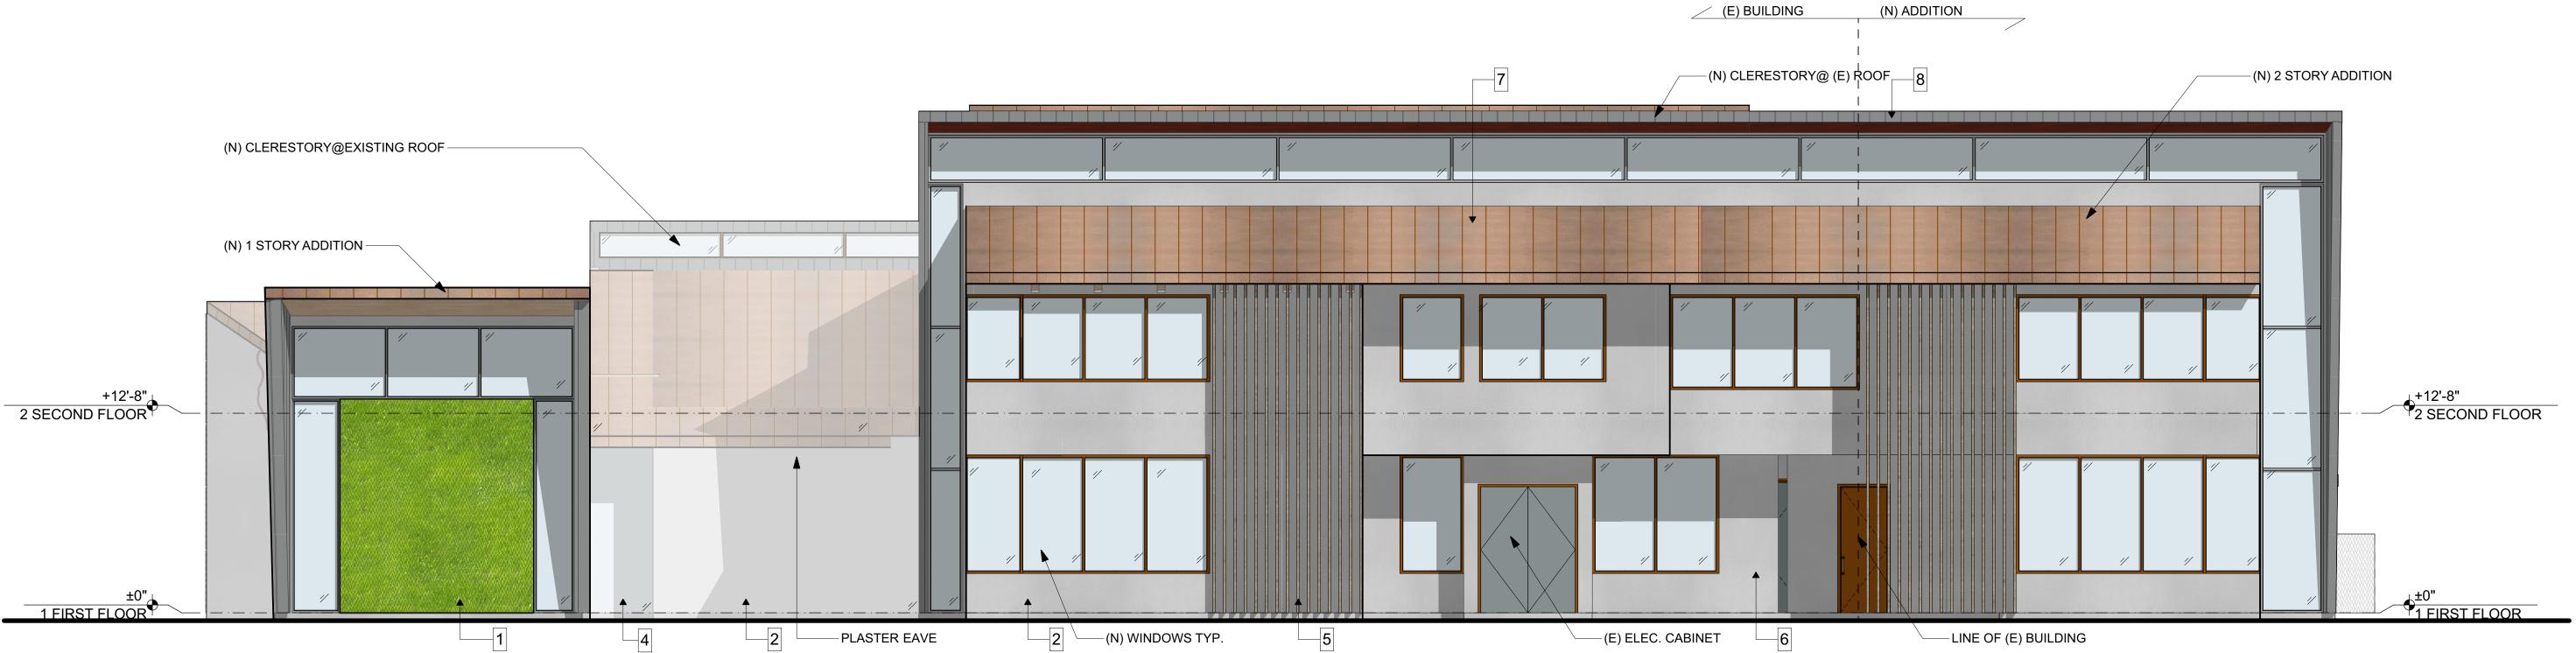

NORTH ELEVATION

SCALE: 3/16" = 1'-0"

issues and revisions | \frac{1}{2} | **o** | 0 | 0 | 4 | registration & signature



project: 725 S VICTORIA AVE

project number	* PROJECT NUMBE
description	
A4.01 BUILDI	NG ELEVATION
(NOPT	H & WEST)


(NORTH & WEST) **AS NOTED** drawn

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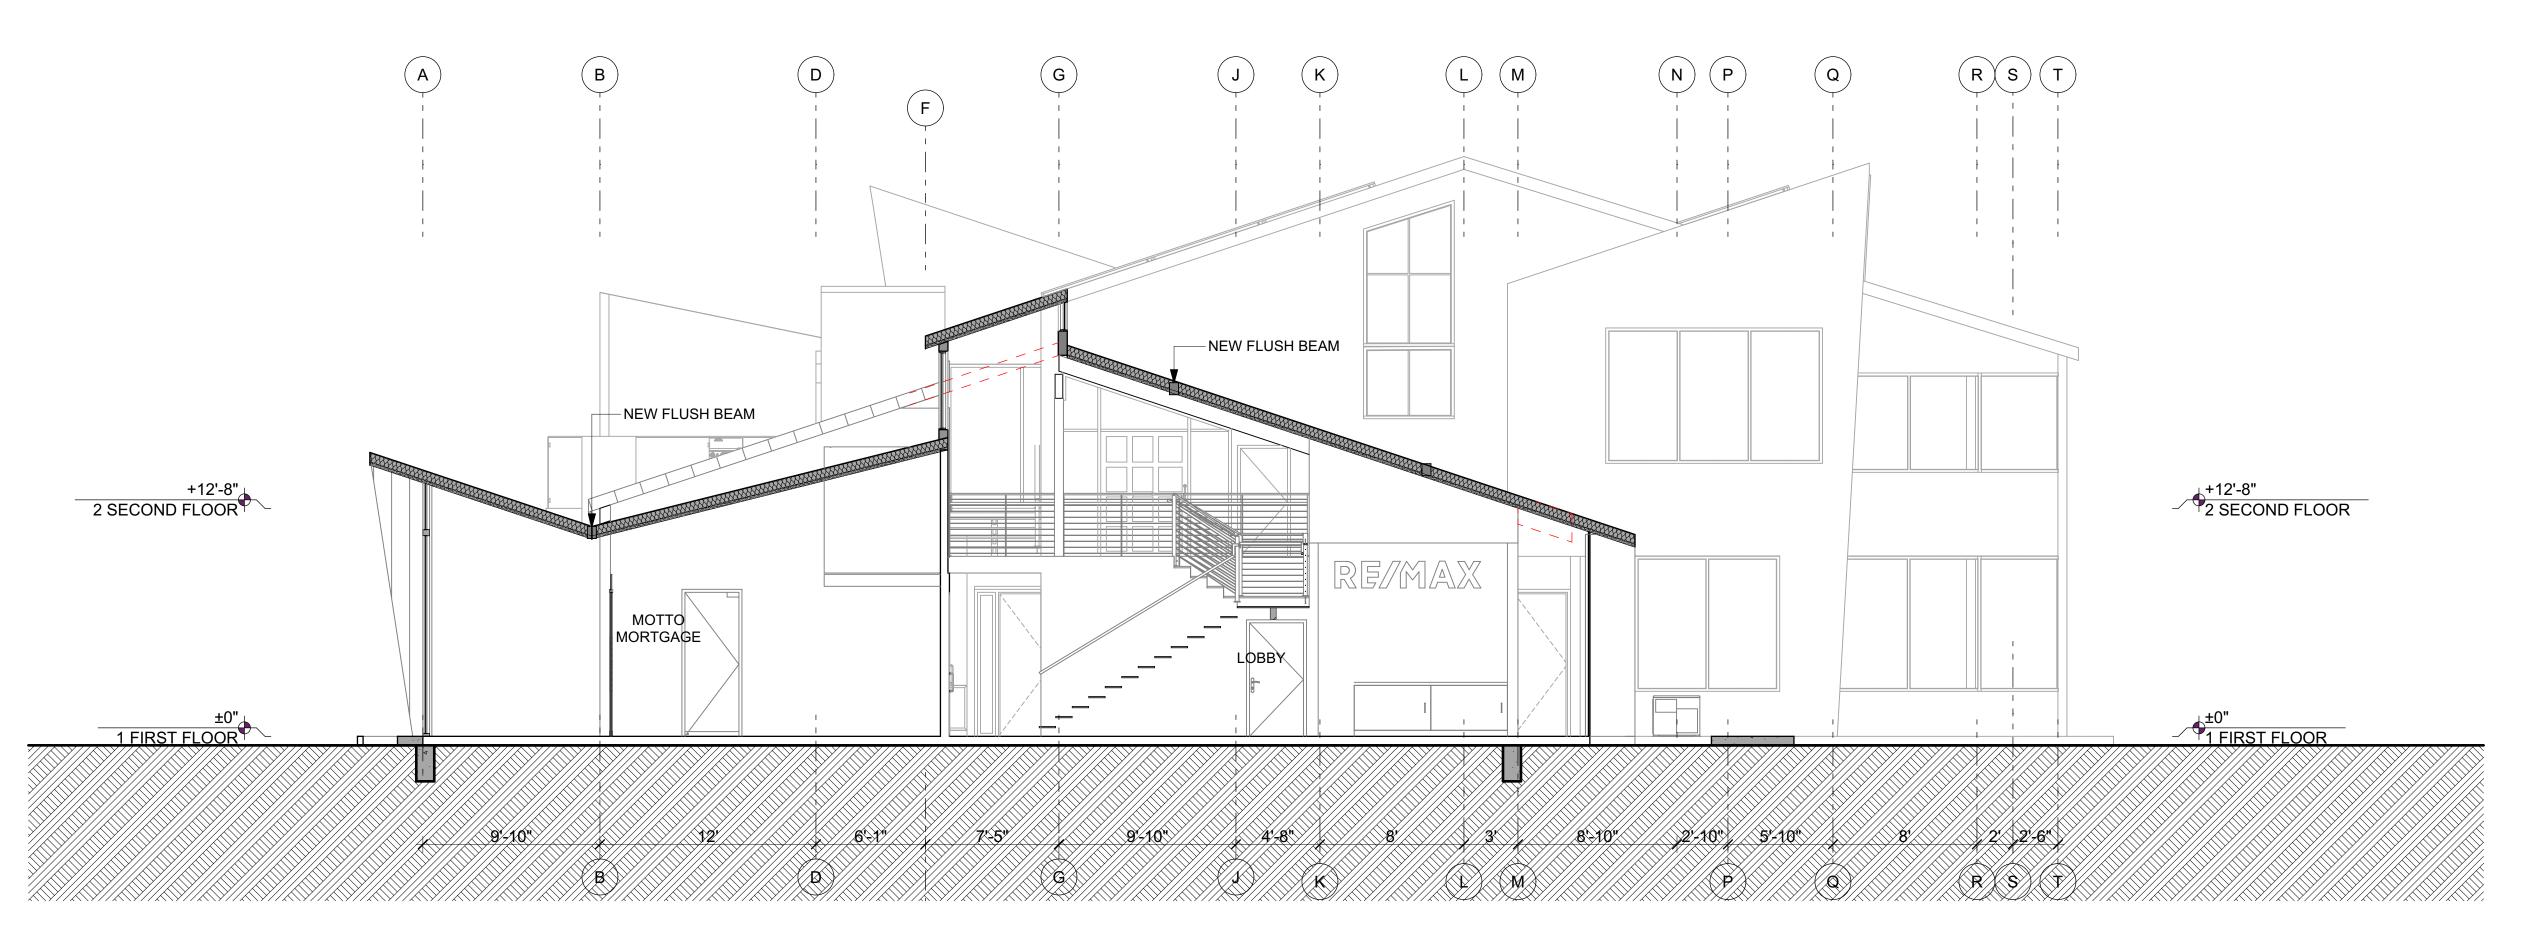
A4.01

drawing number



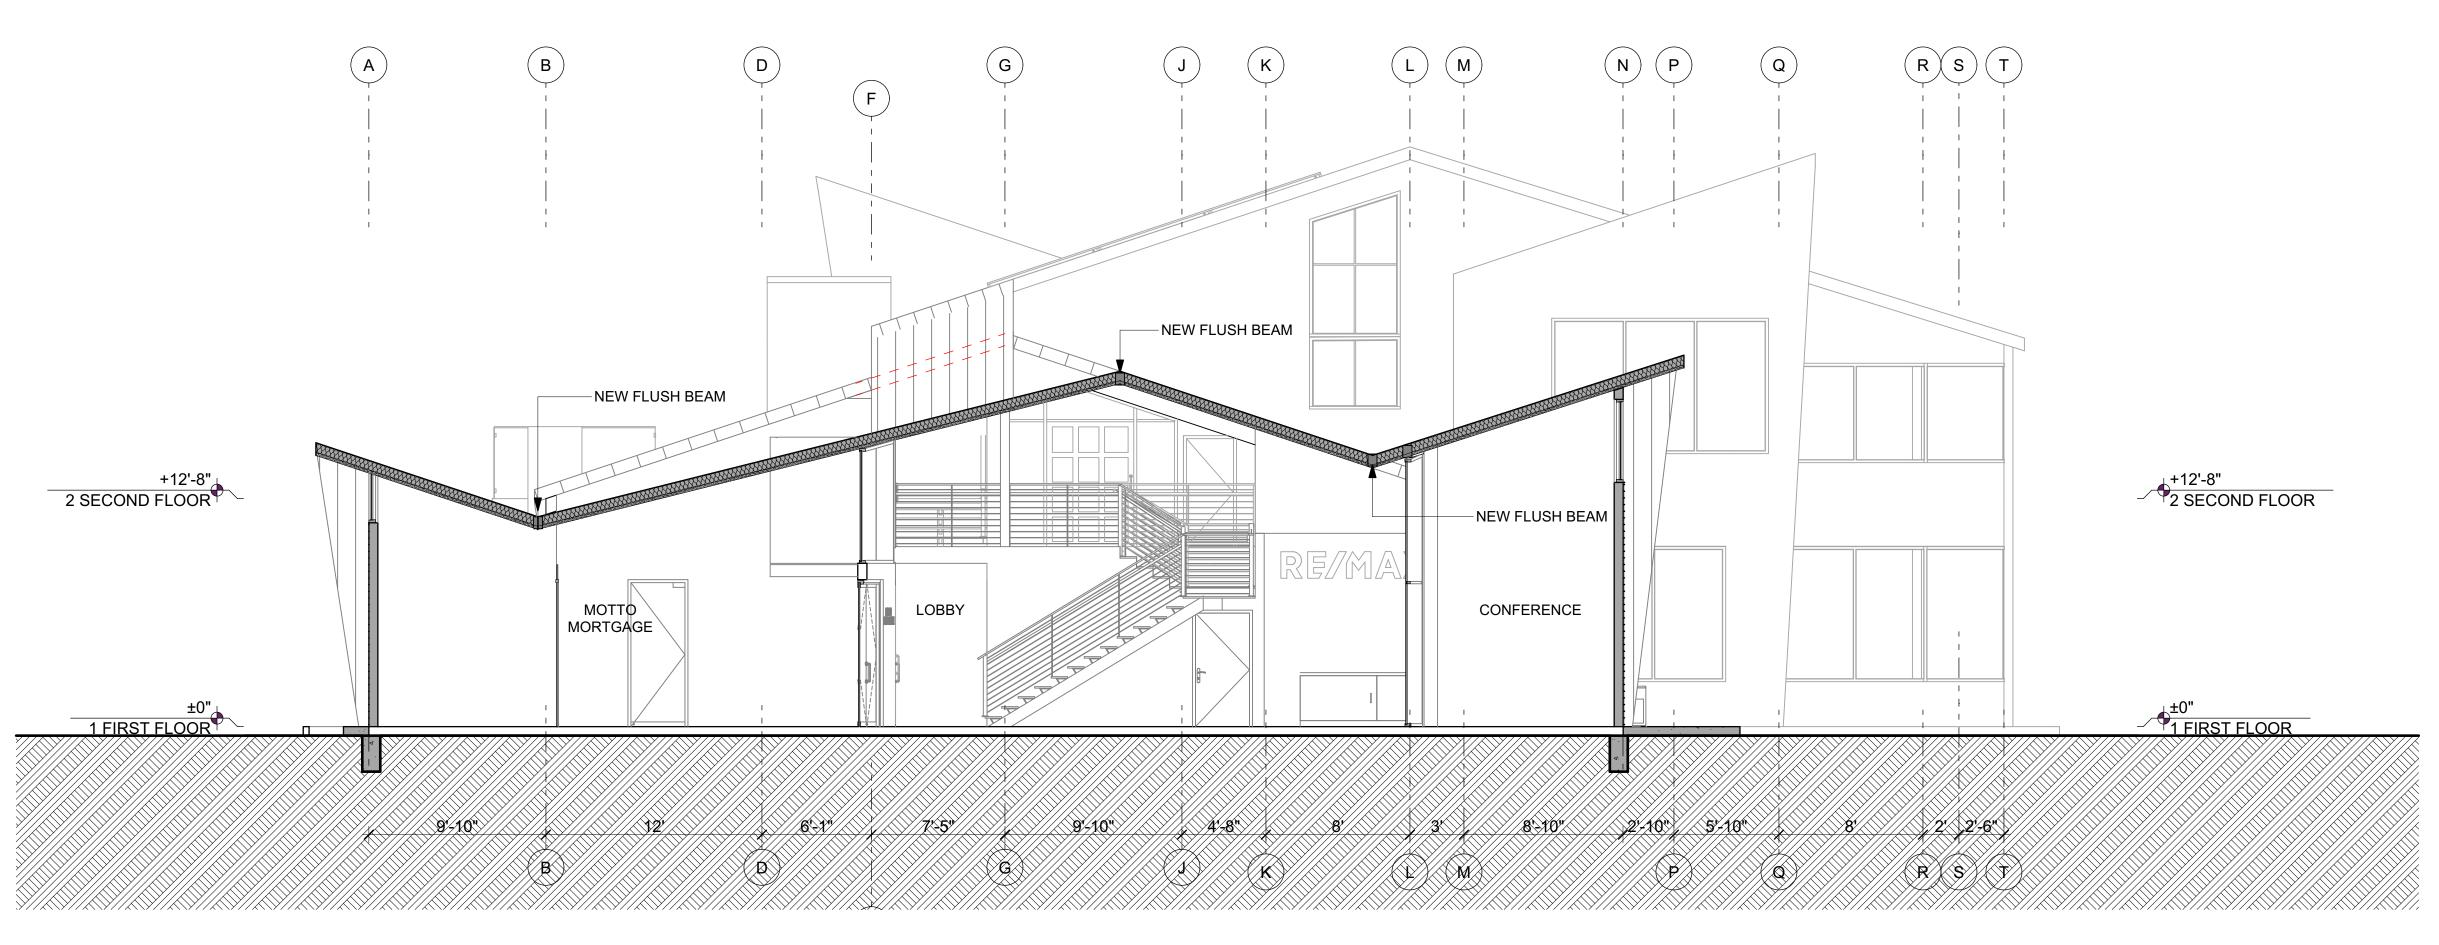

A SECTION THROUGH (N) LOBBY LOOKING WEST




SECTION THROUGH (N) LOBBY STAIRWAY LOOKING WEST

В

RE/MAX
Gold Coast

725 S. VICTORIA AVE VENTURA CA 93003

nest

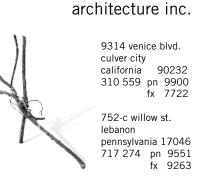

legend

issues and revisions

	DATE	ISSUE	Checked by	Approved by
03	11/29/2021	ISSUE FOR PLAN CHECK	NX	ΑУ
04	2/8/2022	PLANNING RESUBMITTAL	KN	КР
l				

registration & signature




project: 725 S VICTORIA AVE

project number	* PROJECT NUMBE				
description					
A5.01 BUILDING SECTION					
scale	AS NOTED				
drawn	KN				


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north arrow drawing number

A5.01

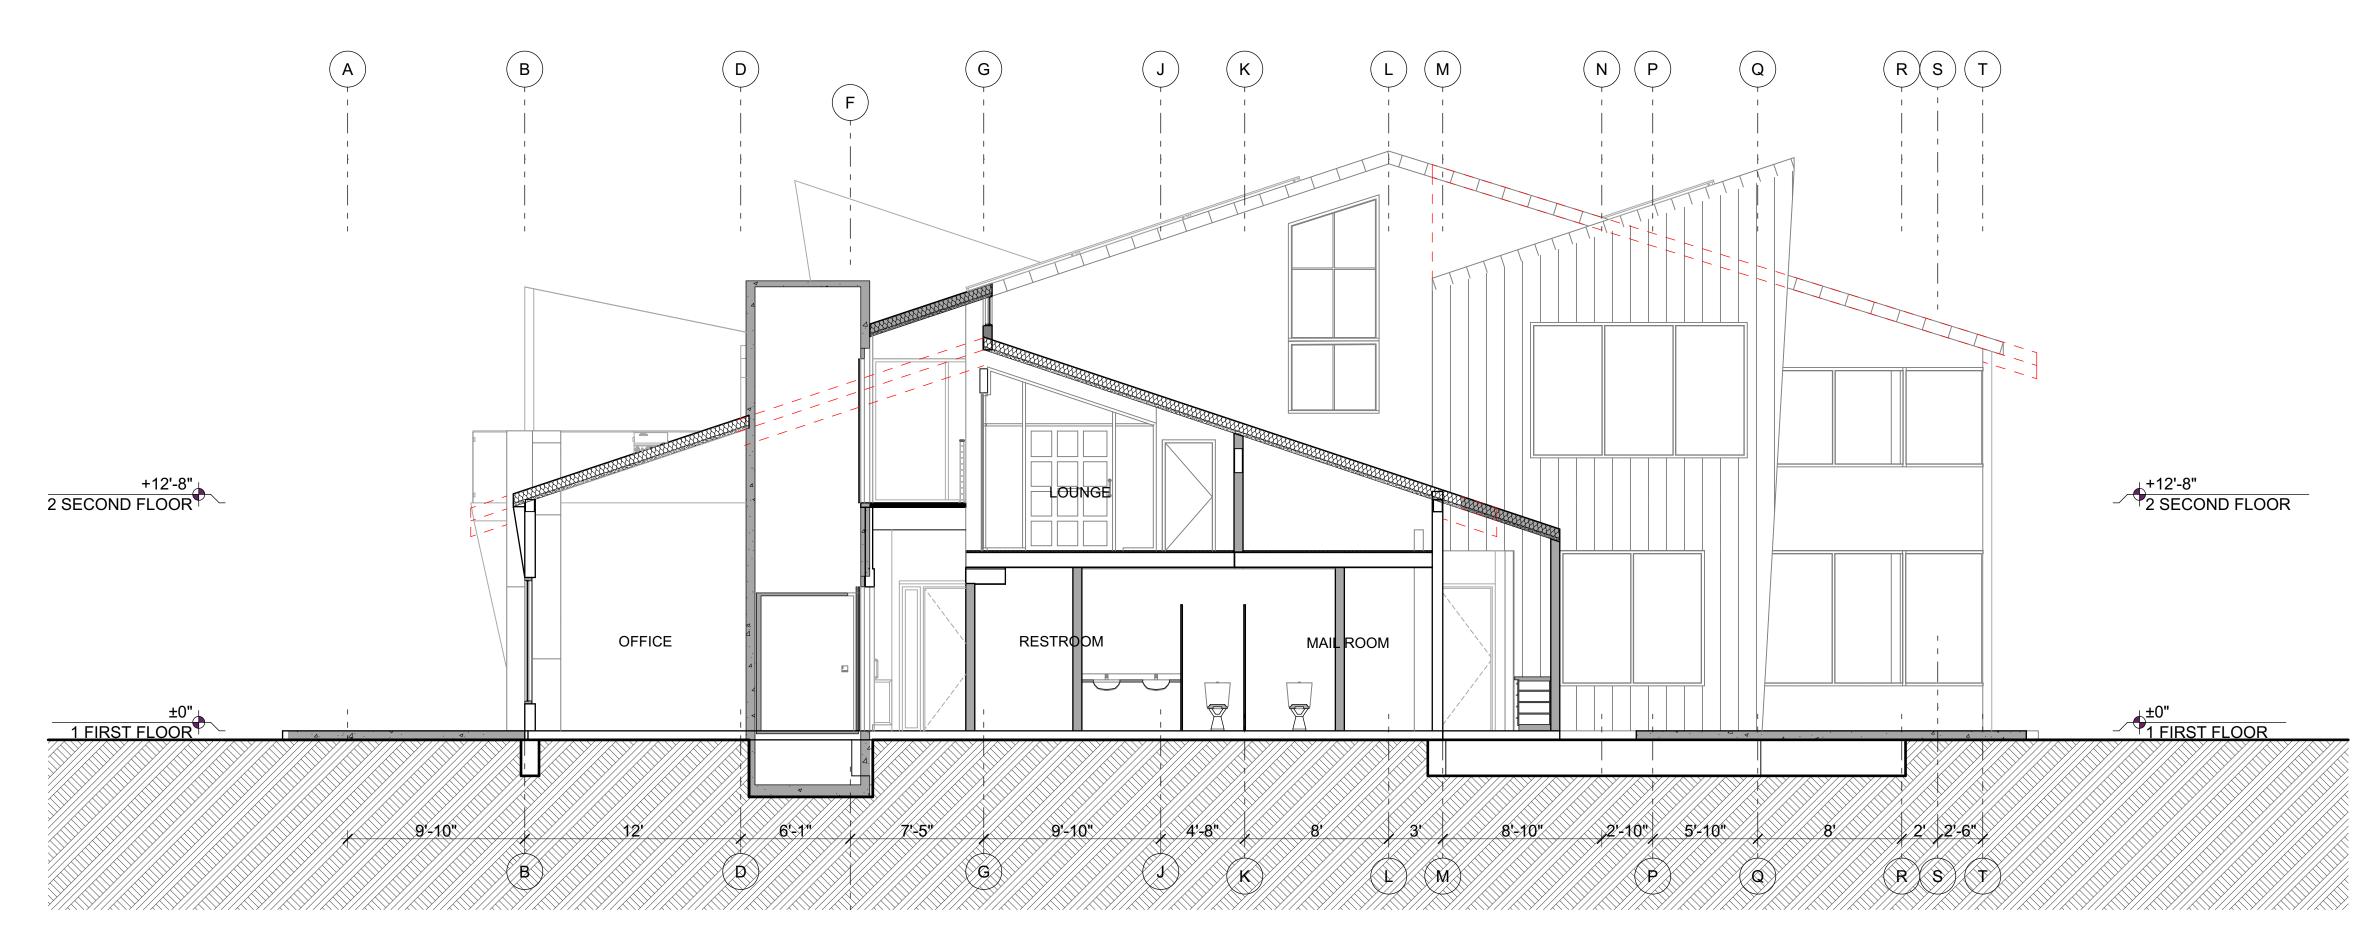

C SECTION THROUGH (N) ELEVATOR SHAFT @ EXISTING STRUCTURE LOOKING WEST SCALE: 3/16" = 1'-0"

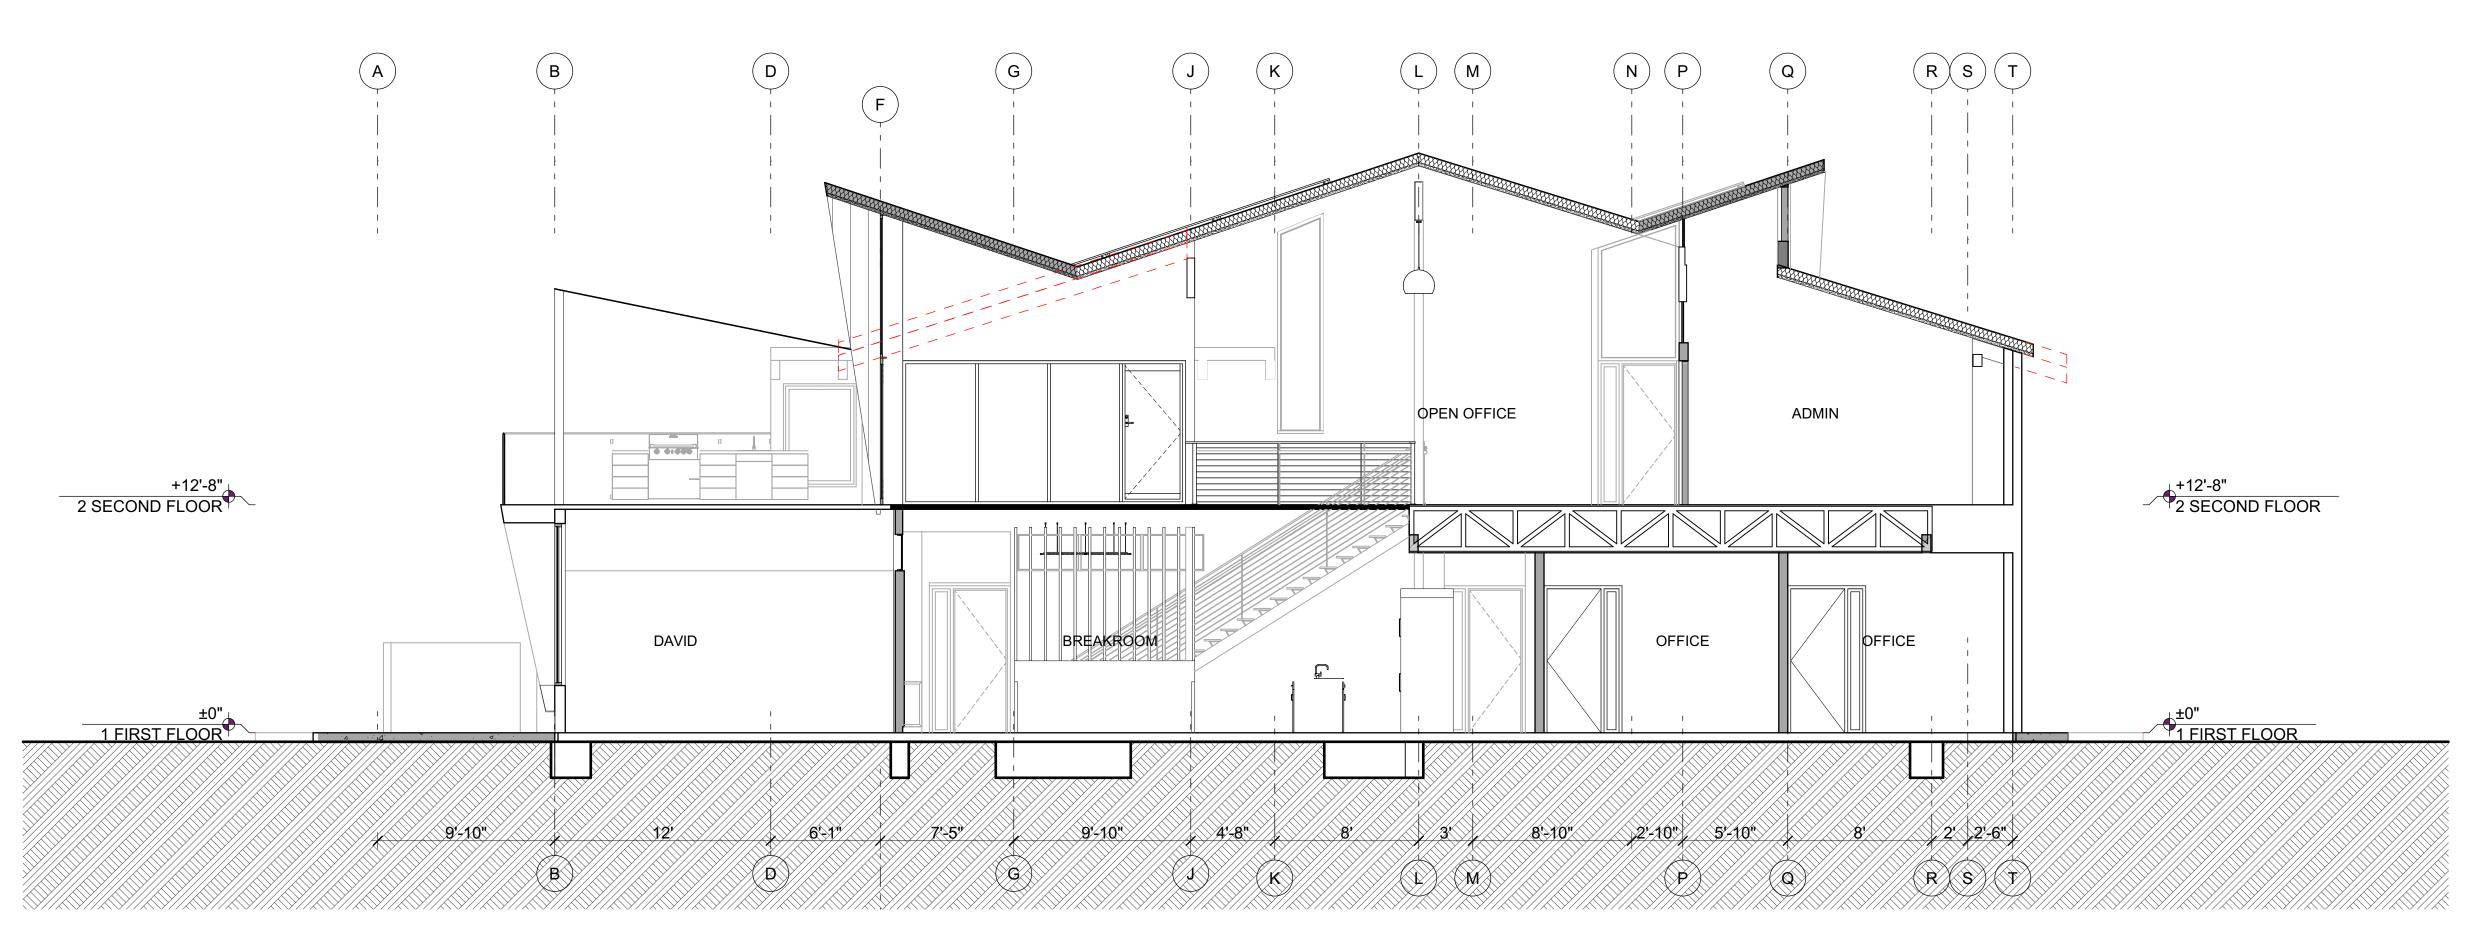


D SECTION THROUGH (E) BUILDING LOOKING WEST

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Gold Coast

725 S. VICTORIA AVE VENTURA CA 93003

nest

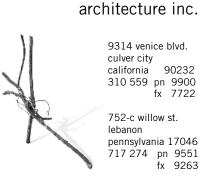

legend

issues and revisions

Approved by	КР	КР				
Checked by	KN	KN				
ISSUE	ISSUE FOR PLAN CHECK	PLANNING RESUBMITTAL				
DATE	11/29/2021	2/8/2022				
aı	03	04				
				 	_	

registration & signature



project: 725 S VICTORIA AVE

project number	* PROJECT NUMBER *							
description								
A5.02 BUILDING SECTIONS								
scalo	AS NOTED							


drawn KN


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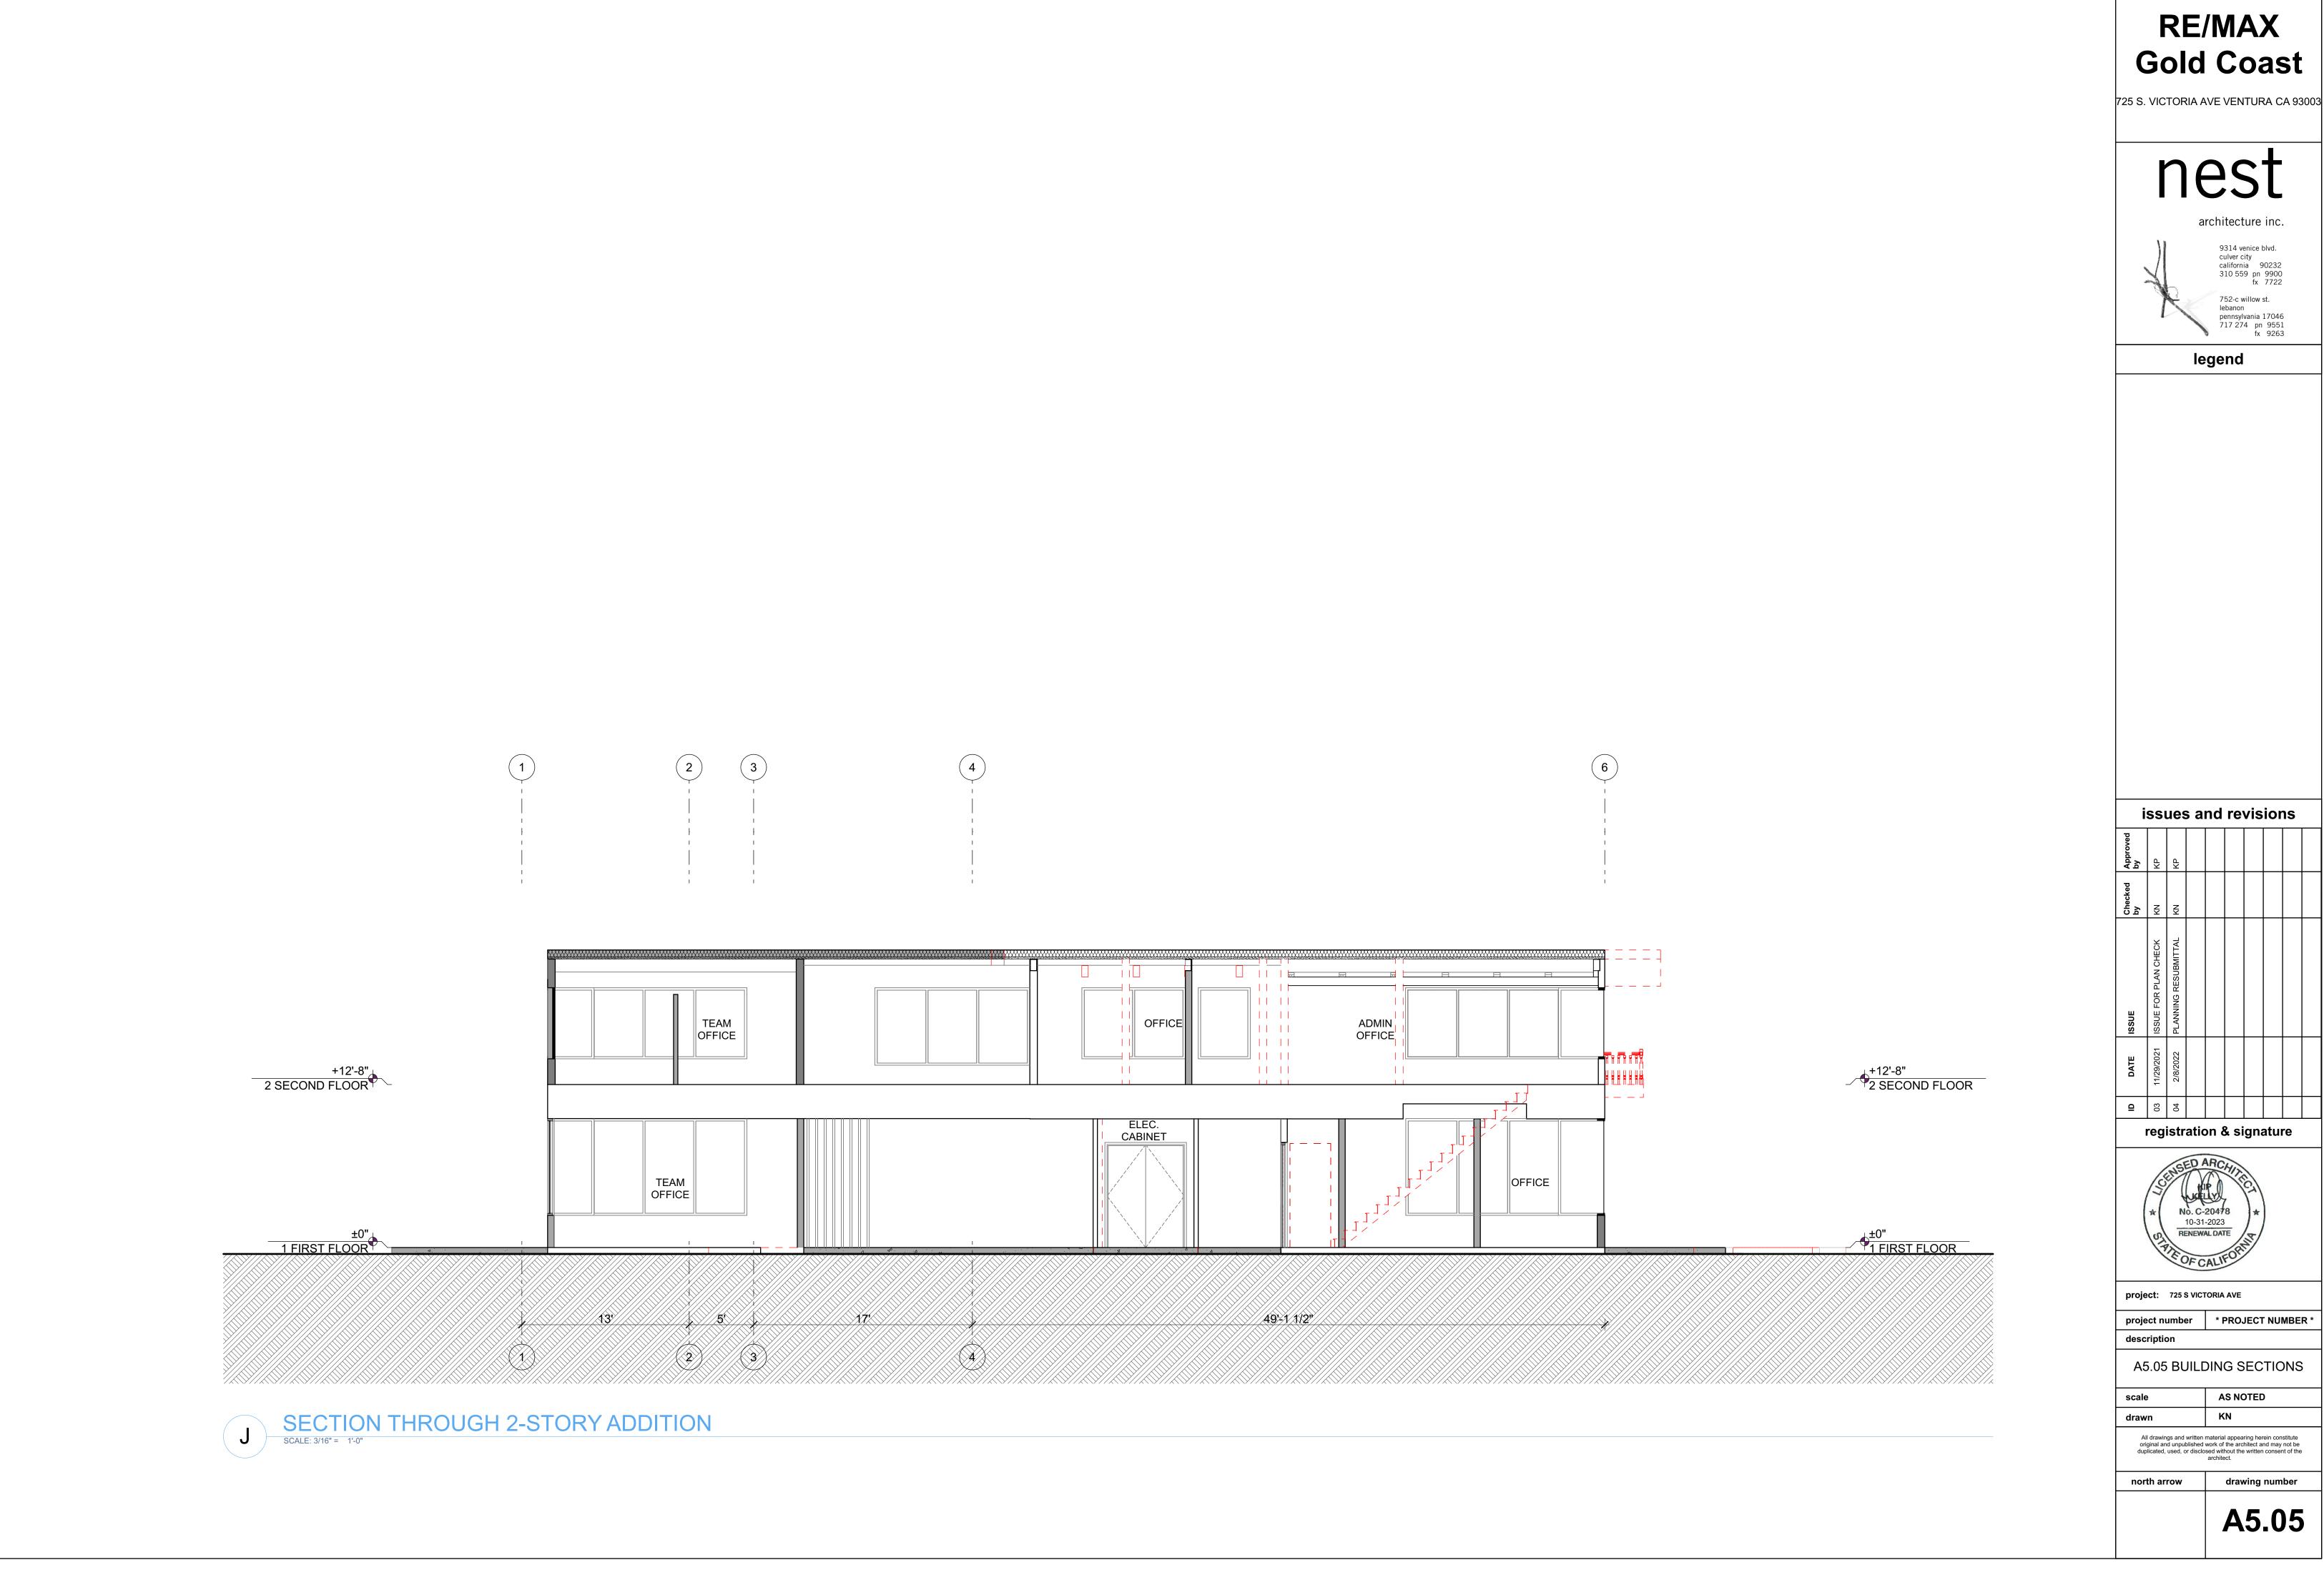
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A5.02

drawing number






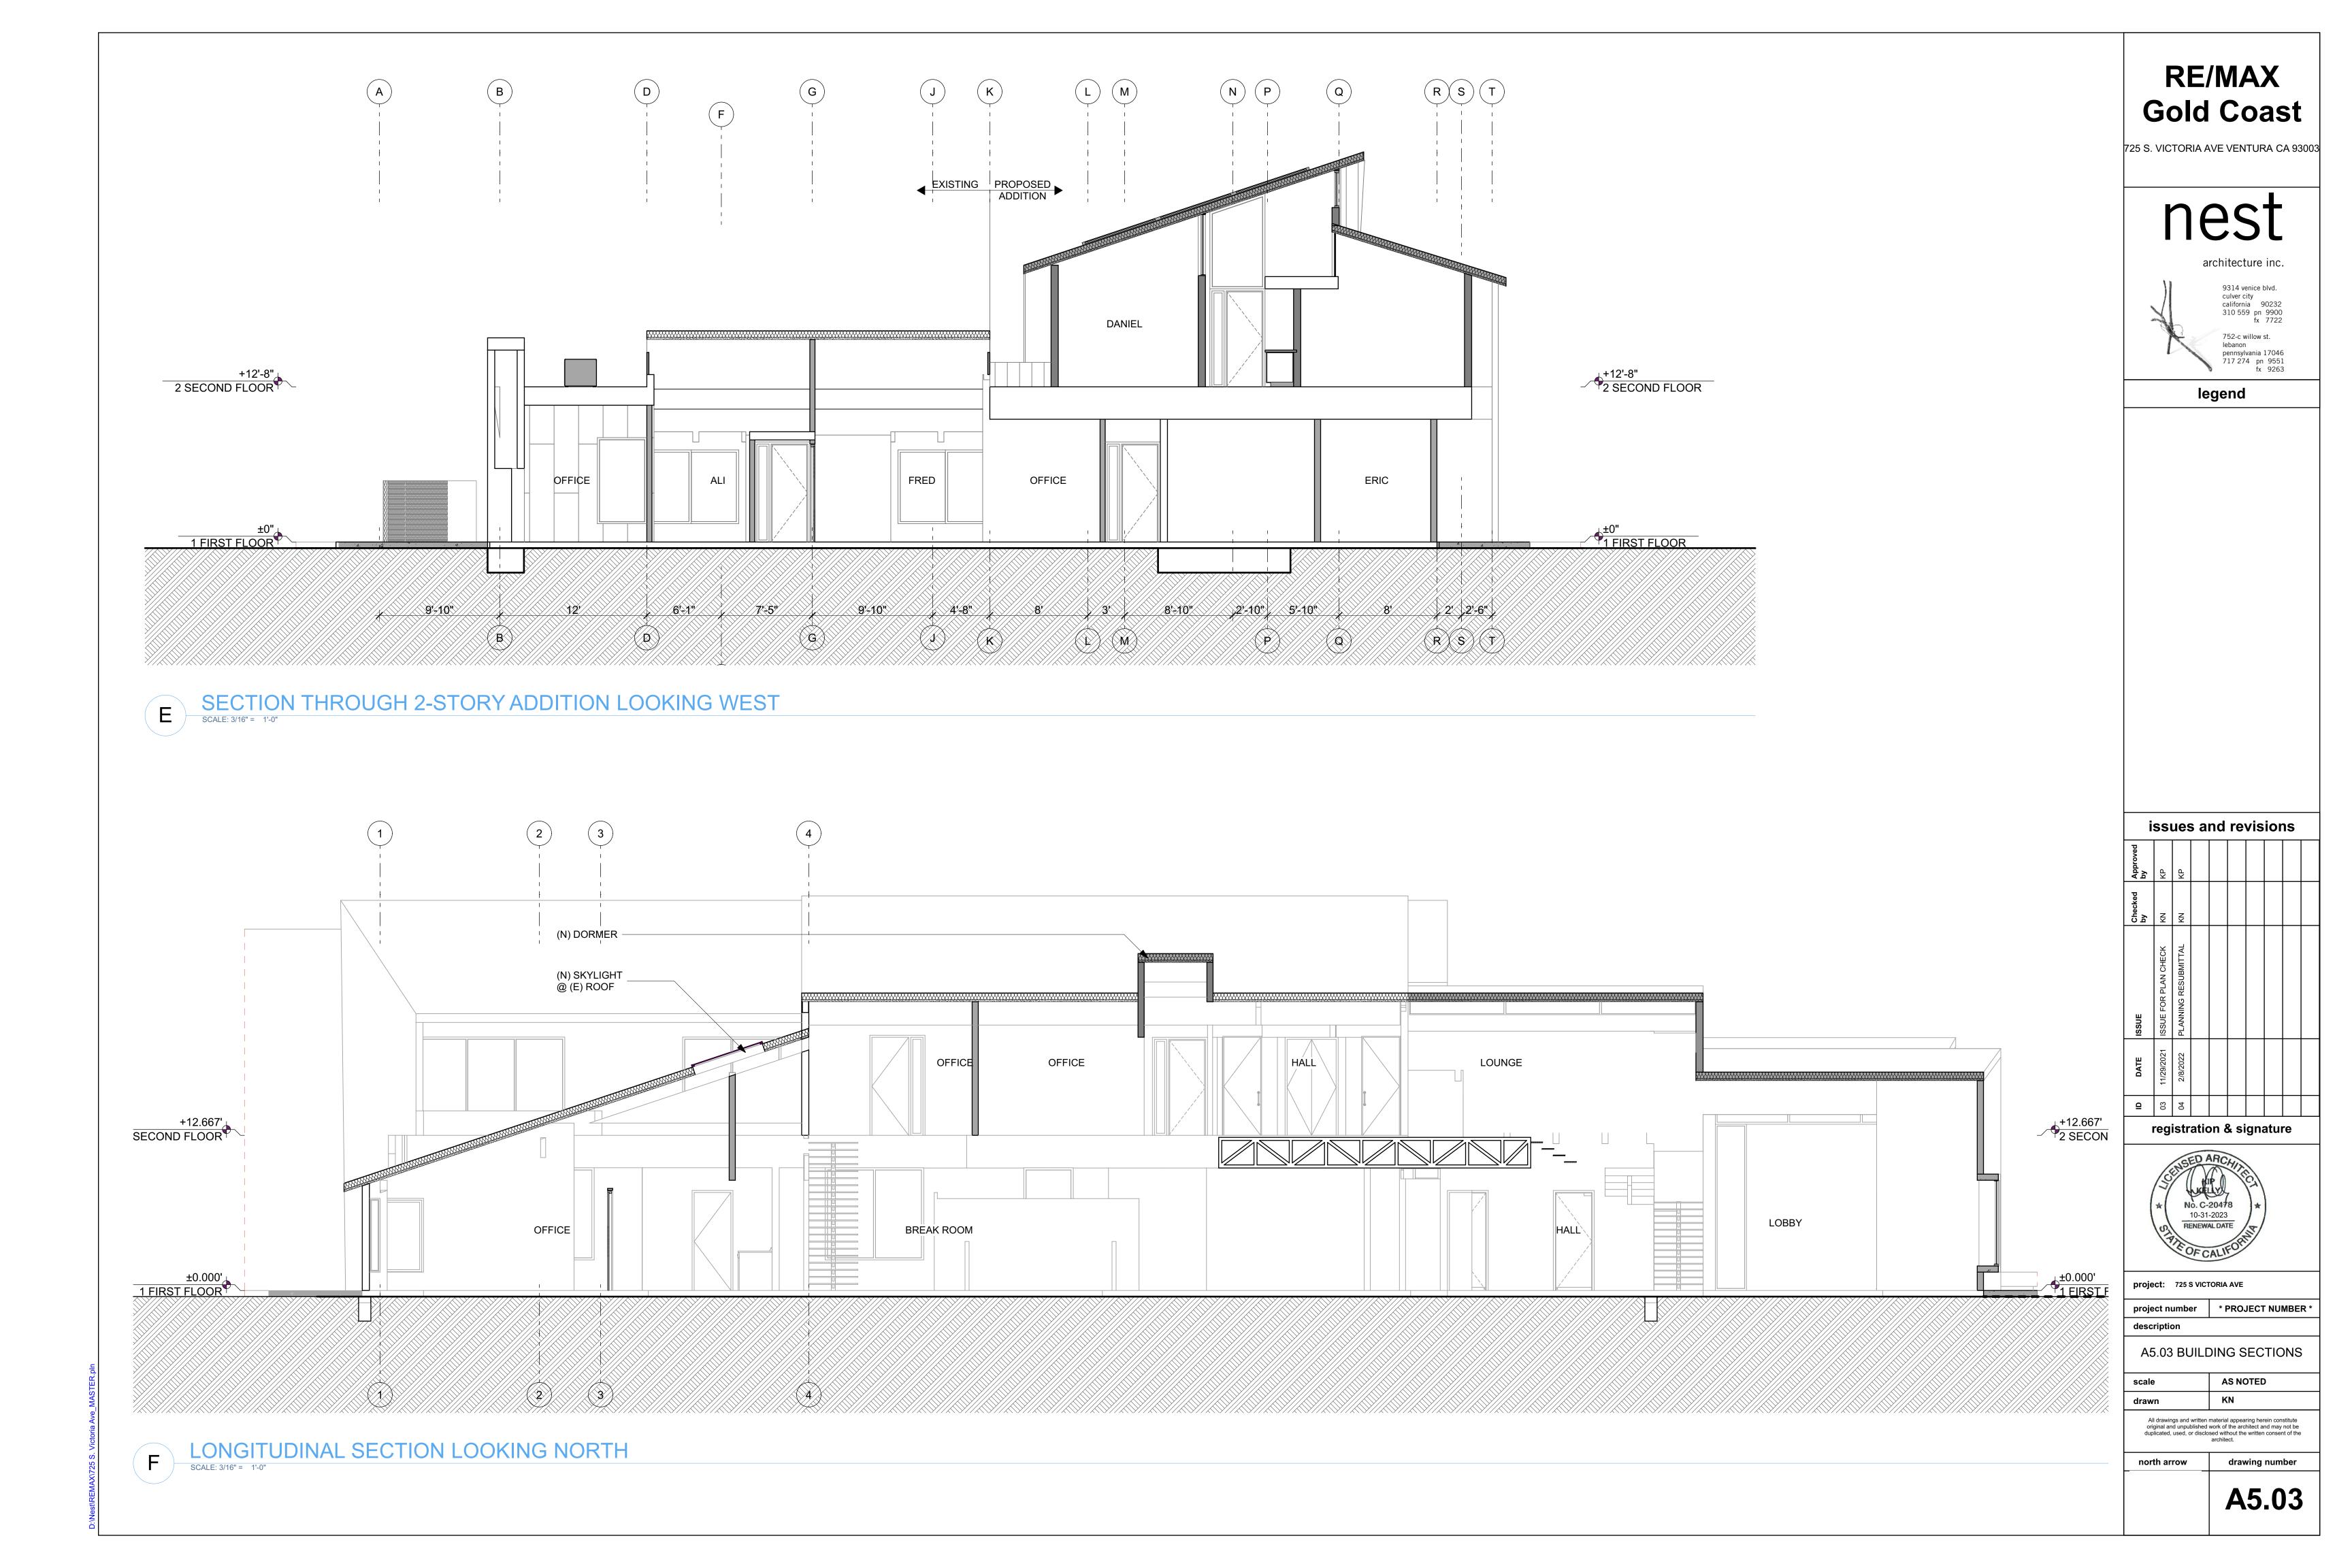
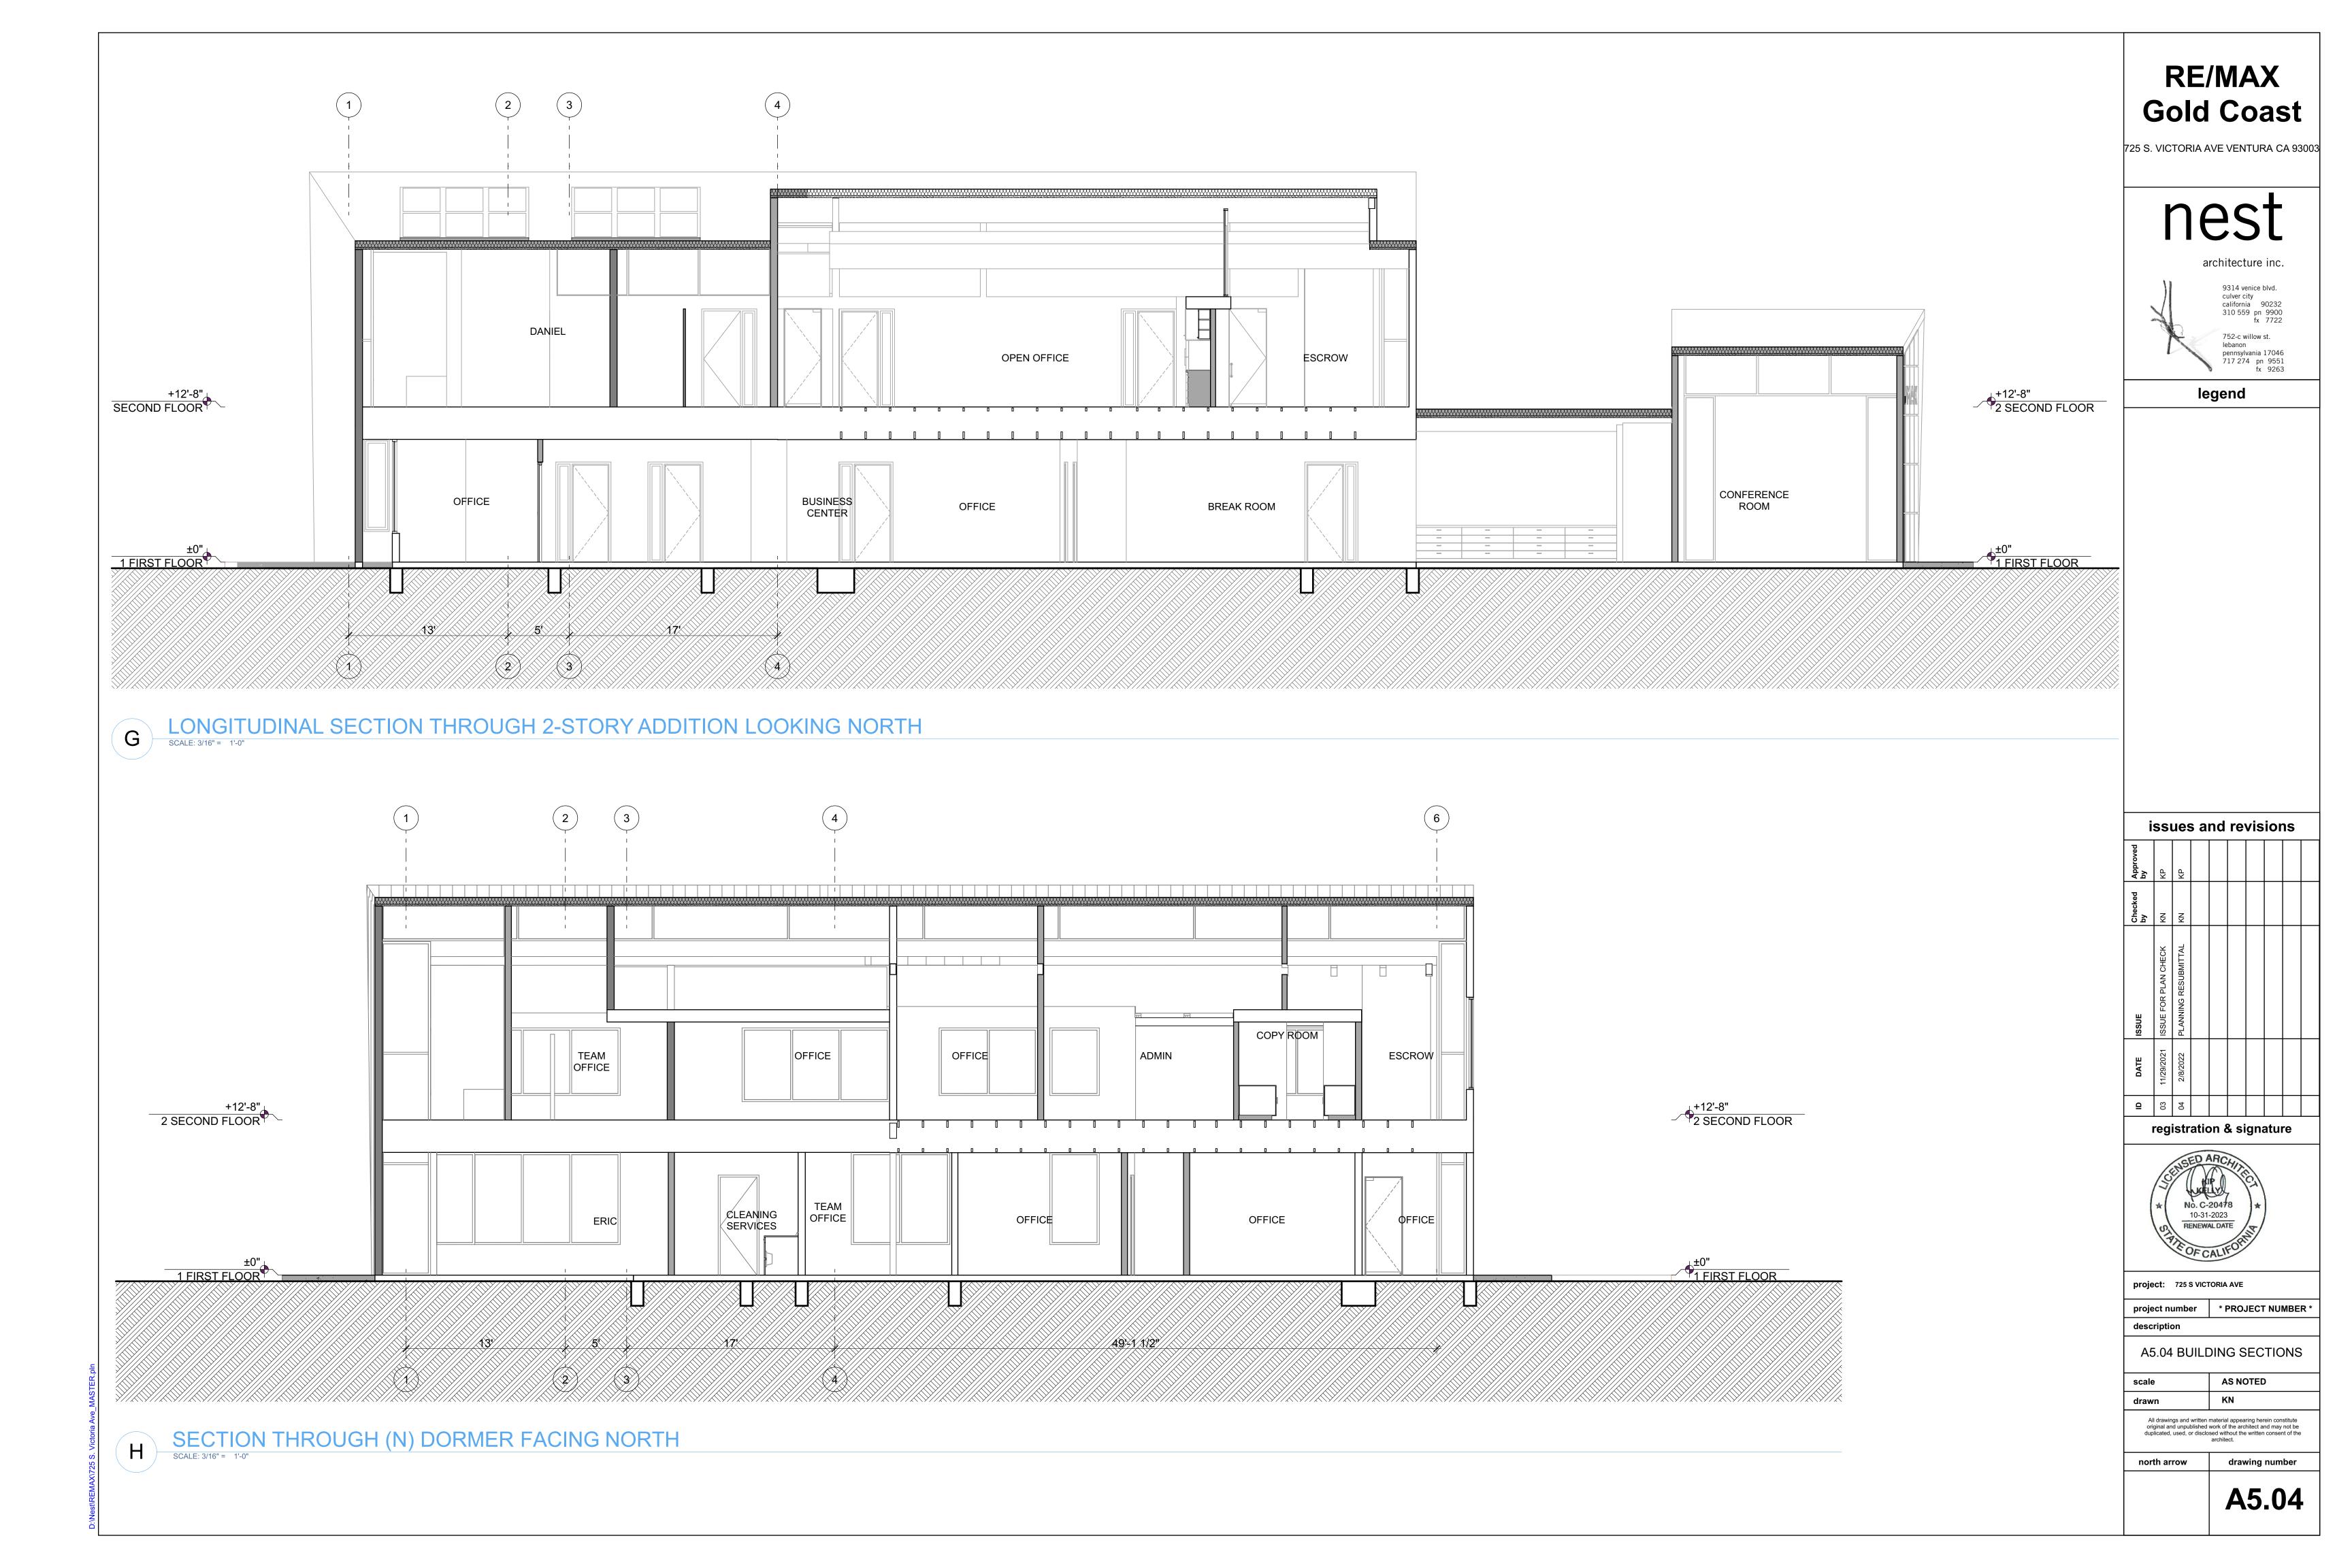
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	Approved by	КР	КР							
	Checked by	NY	NY							
	ISSUE	ISSUE FOR PLAN CHECK	PLANNING RESUBMITTAL							
	DATE	11/29/2021	2/8/2022							
г										


project number	PROJECT NUMBER						
description							
A5.05 BUILE	DING SECTIONS						
scale	AS NOTED						


A5.05

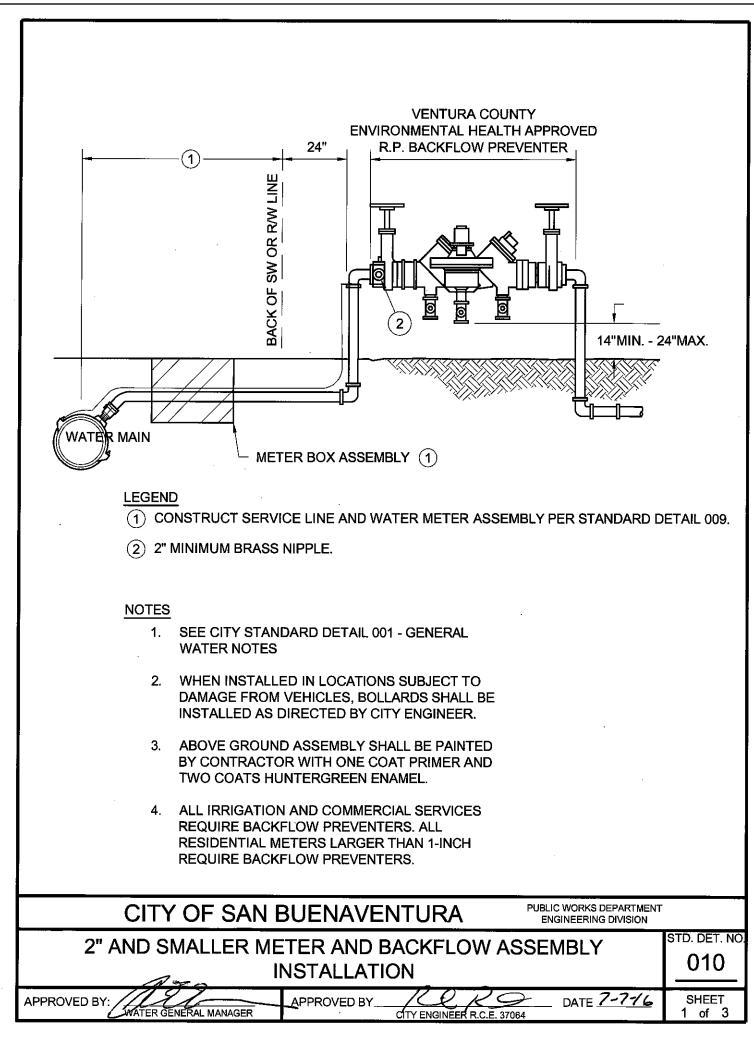


CITY STANDARD DETAIL #10

CITY STANDARD DETAIL #21

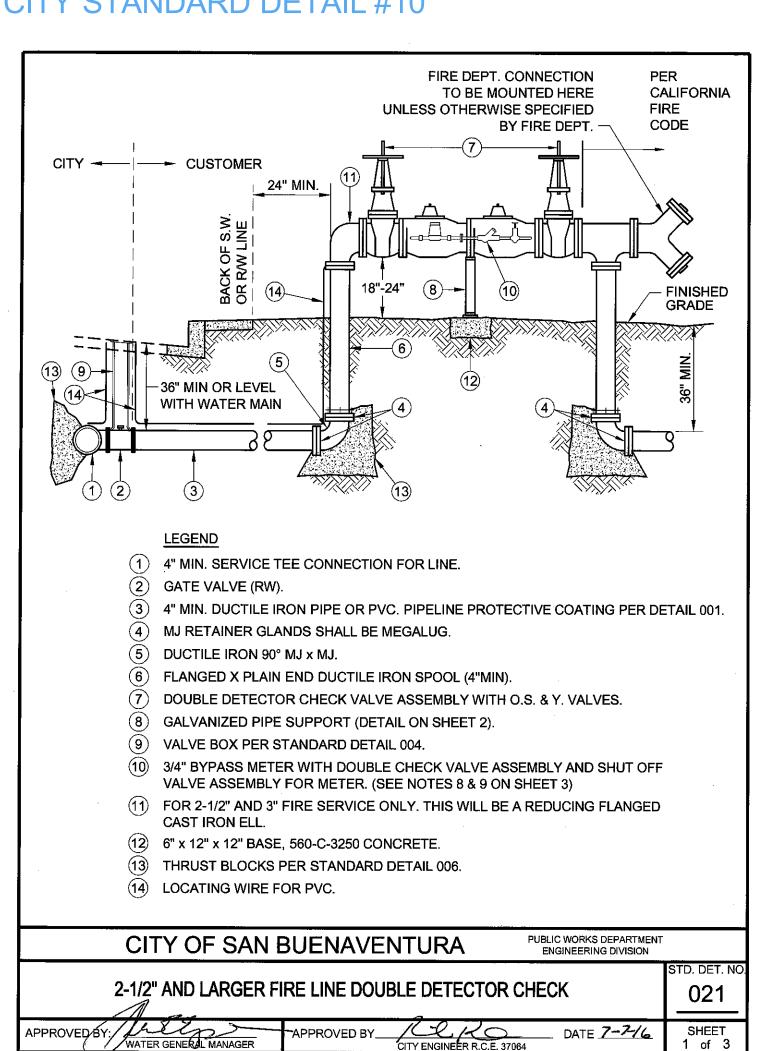


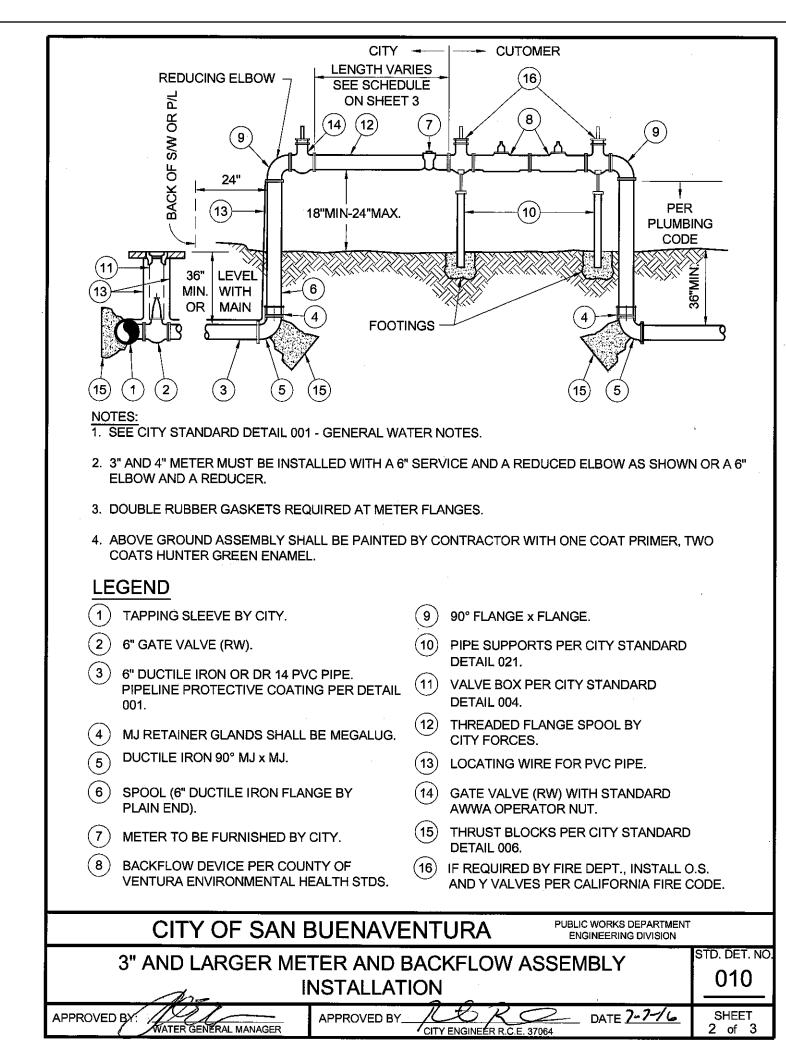


CITY STANDARD DETAIL #10

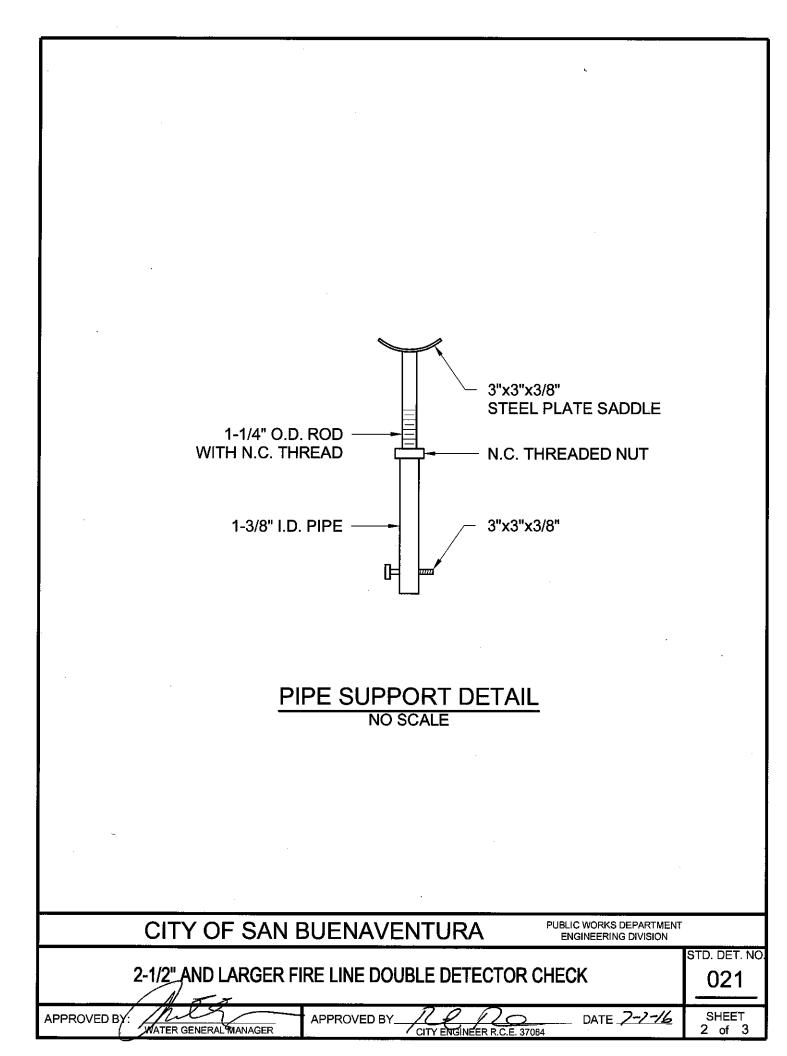

CITY STANDARD DETAIL #21

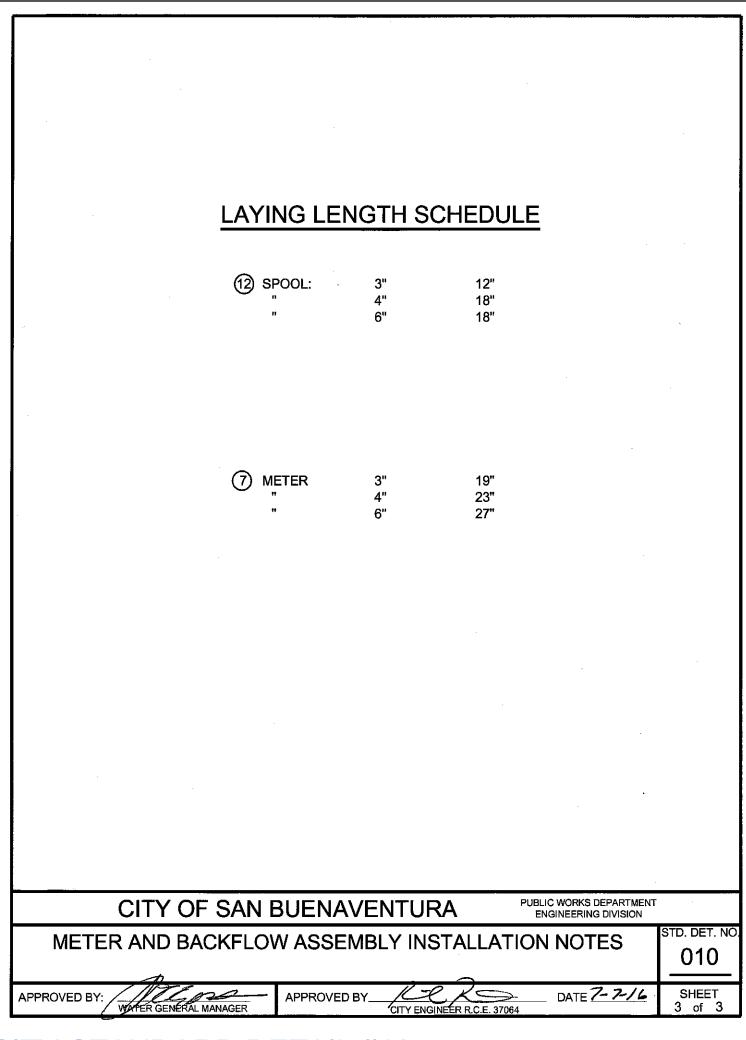

CITY STANDARD DETAIL #10

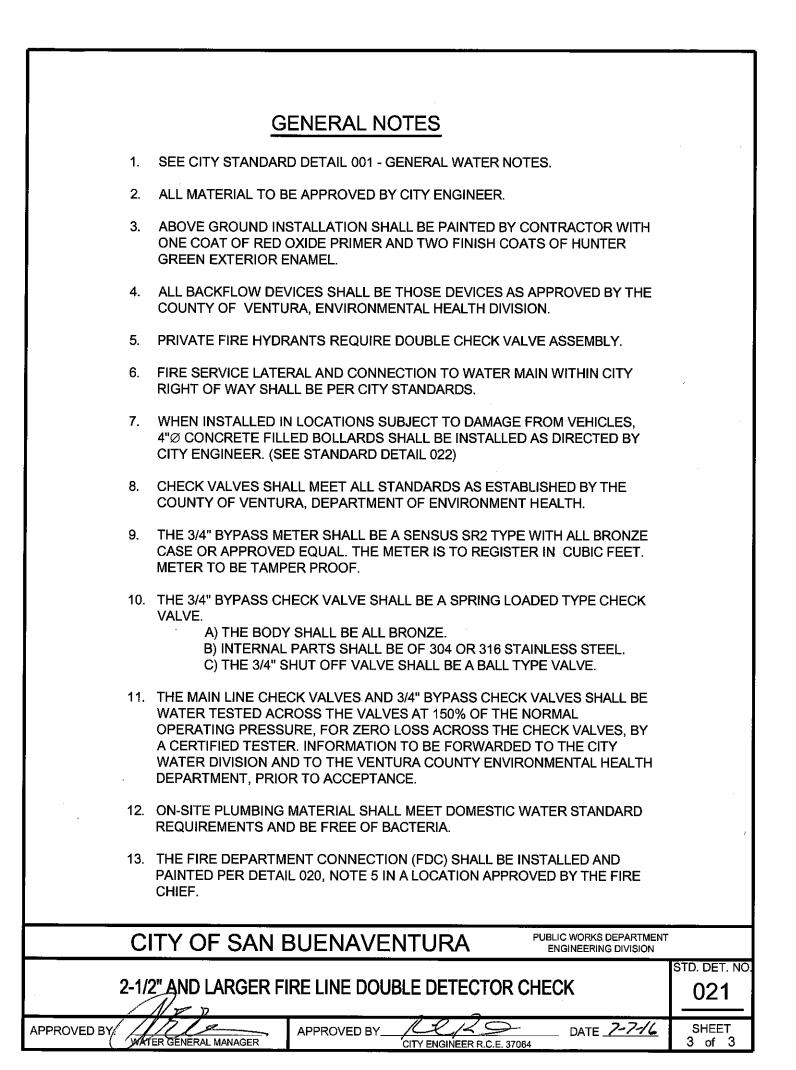



725 S. VICTORIA AVE VENTURA CA 93003

architecture inc. 9314 venice blvd. california 90232 310 559 pn 9900 752-c willow st. pennsylvania 17046 717 274 pn 9551

legend

registration & signature

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issues and revisions




project: 725 S VICTORIA AVE

project number * PROJECT NUMBER * description A8.04 CITY STANDARD DETAIL

AS NOTED drawn

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north arrow drawing number

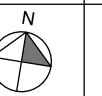

A8.04













RE/MAX Gold Coast

725 S. VICTORIA AVE VENTURA CA 93003

legend

issues and revisions

registration & signature




project: 725 S VICTORIA AVE

project number * PROJECT NUMBER *				
description				
A9.01 RI	ENDERINGS			

AS NOTED

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RE/MAX Gold Coast
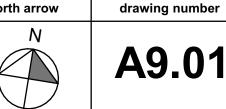
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architecture inc.


9314 venice blvd. culver city california 90232 310 559 pn 9900 fx 7722 752-c willow st. lebanon pennsylvania 17046 717 274 pn 9551 fx 9263

legend

issues and revisions

<u>Q</u>	DATE	ISSUE	Checked by	Approved by
03	11/29/2021	ISSUE FOR PLAN CHECK		
04	2/8/2022	PLANNING RESUBMITTAL		

registration & signature

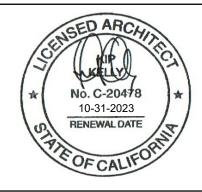

project: 725 S VICTORIA AVE

project number * PROJECT NUMBER *

A9.02 SUN STUDY

AS NOTED

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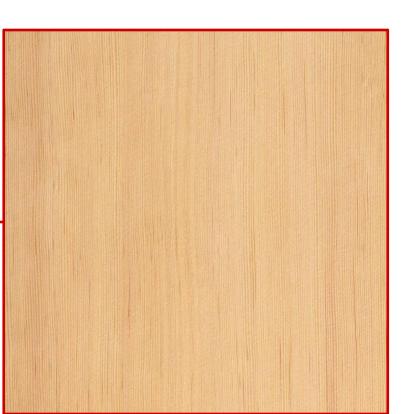
north arrow drawing number



A9.02


SIDING: CORRUGATED METAL

ROOF:
DARK BRONZE STANDING SEAM METAL



WALLS: EXTERIOR CEMENT PLASTER SMOOTH

FINISH, COLOR:GRAY

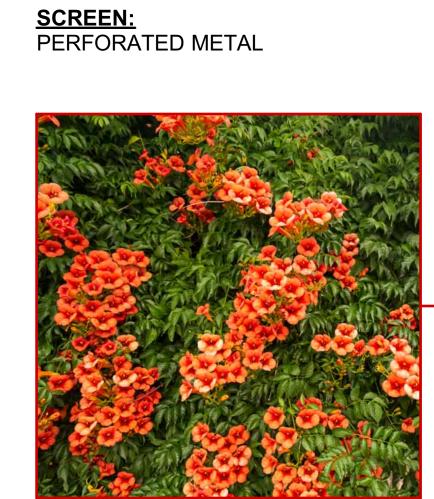

WINDOW & DOOR FRAMES: DARK BROWN ANODIZED

GREEN WALL: RED TRUMPET VINE, SEE LANDSCAPE PLANS



RE/MAX Gold Coast

725 S. VICTORIA AVE VENTURA CA 93003

nest


architecture inc. 9314 venice blvd. culver city california 90232 310 559 pn 9900 fx 7722 752-c willow st. lebanon pennsylvania 17046 717 274 pn 9551 fx 9263

legend

issues and revisions

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registration & signature

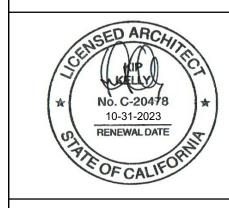

project: 725 S VICTORIA AVE


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project number * PROJECT NUMB				
description				
A9.03 MATERIAL BOAR				
scale	AS NOTED			
drawn	KN			

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drawing number





KEY TO EXIST TREES (INVENTORY) & ACTION:

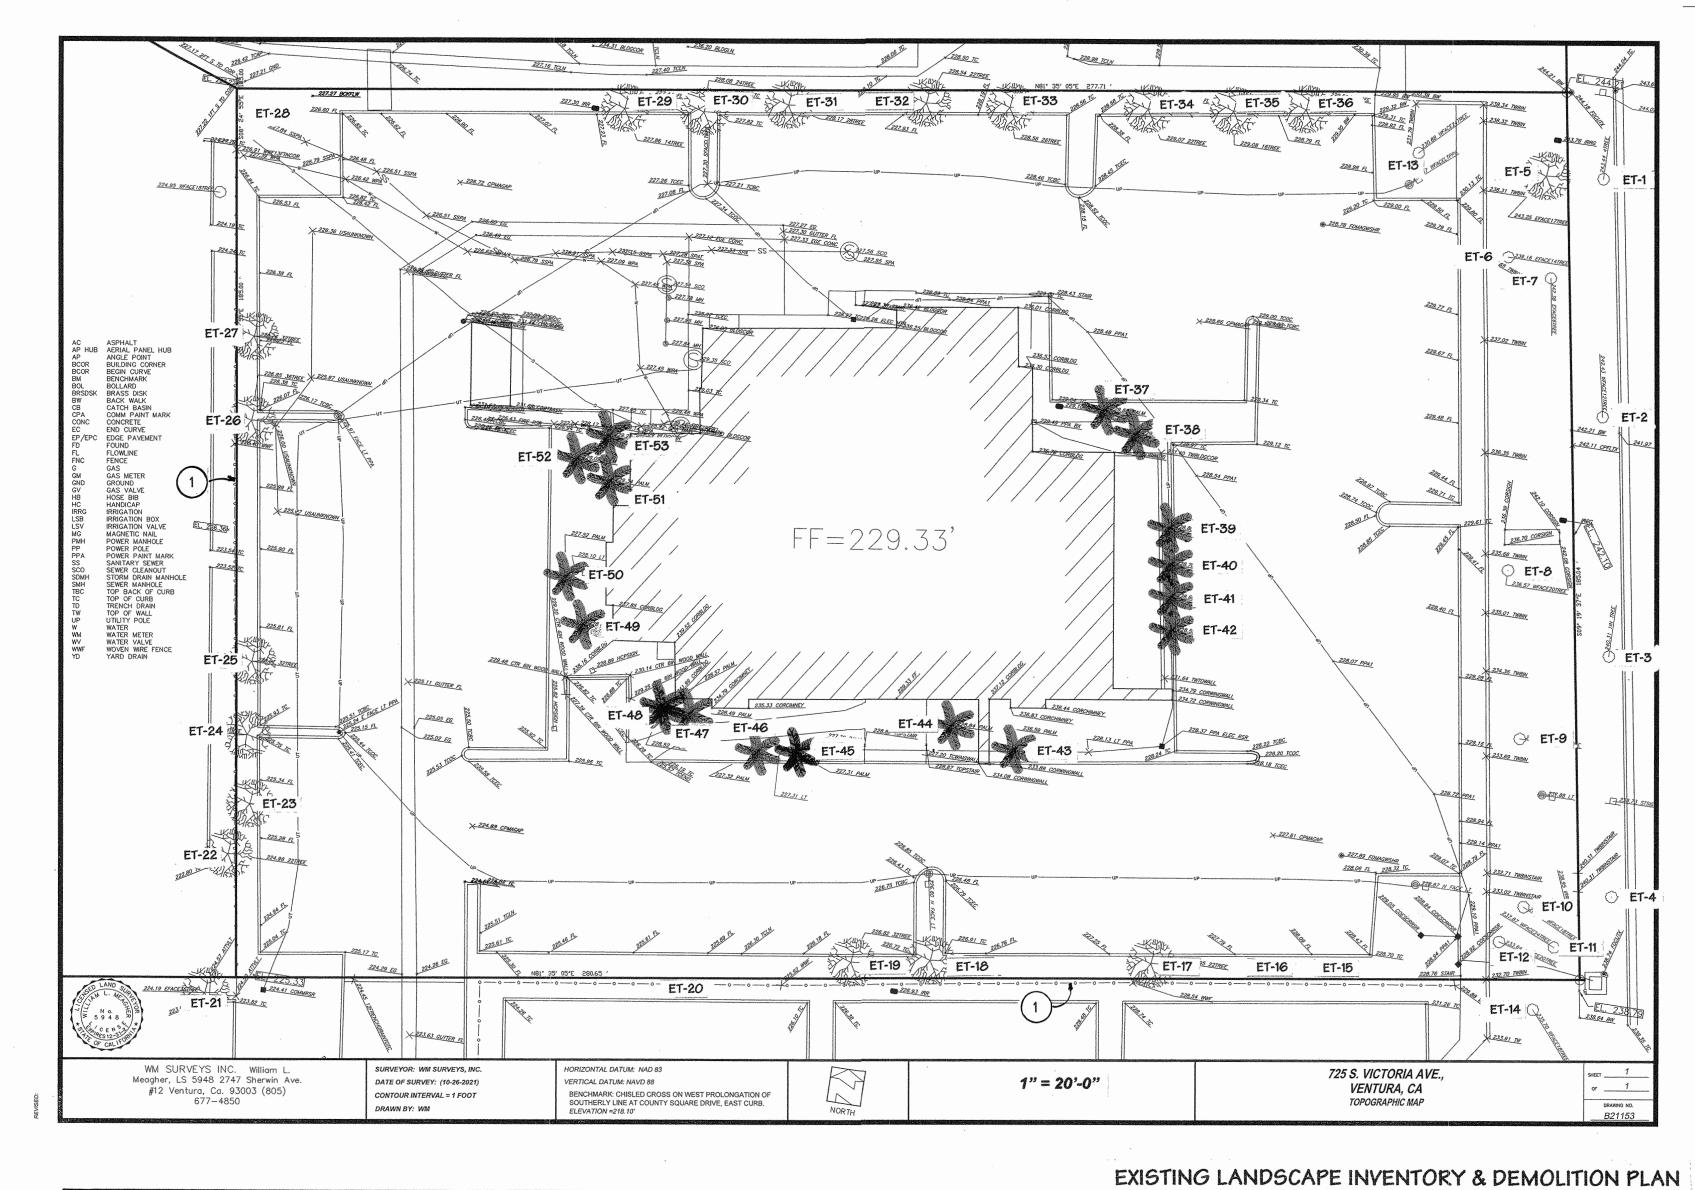KEY	EXISTING TREE	ACTION
ET-1	QUERCUS ILEX	STREET TREE
ET-2	QUERCUS ILEX	STREET TREE
ET-3	GINKO BILOBA	STREET TREE
ET-4	QUERCUS ILEX	STREET TREE
ET-5	EUCALYPTUS	REMAINS
ET-6	EUCALYPTUS	REMAINS
ET-7	EUCALYPTUS	REMAINS
ET-8	EUCALYTPUS	REMAINS
ET-9	EUCALYPTUS	REMAINS
ET-10	EUCALYPTUS	REMAINS
ET-11	EUCALYPTU6	REMAINS
ET-12	EUCALYPTU6	REMAINS
ET-13	EUCALYPTU6	REMAINS
ET-14	PLATANUS RACEMOSA	REMAINS (OFF-SITE)
ET-15	CUPANIOPSIS STUMP W/SUCKERS	REMOVE
ET-16	CUPANIOPSIS STUMP W/SUCKERS	REMOYE
ET-17	CUPANIOPSIS ANACARDIOIDES	REMOYE
ET-18	CUPANIOPSIS ANACARDIOIDES	REMOYE
ET-19	CUPANIOPSIS ANACARDIOIDES	REMOVE
ET-20	PRUNUS LYONII VOLUNTEER	REMOVE (@ PL)
ET-21	PINUS PINEA	REMAINS (OFF-SITE)
ET-22	EUCALYPYU6	REMAINS
ET-23	CUPANIOPSIS ANACARDIOIDES	REMAINS
ET-24	CUPANIOPSIS ANACARDIOIDES	REMAINS
ET-25	CUPANIOPSIS ANACARDIOIDES	REMAINS
ET-26	CUPANIOPSIS ANACARDIOIDES	REMAINS
ET-27	CUPANIOPSIS ANACARDIOIDES	REMAINS
ET-28	PRUNUS LYONII & MISC	REMOVE
ET-29	CUPANIOPSIS ANACARDIOIDES	REMAINS
ET-30	CUPANIOPSIS ANACARDIOIDES	REMAINS
ET-31	CUPANIOPSIS ANACARDIOIDES	REMAINS
ET-32	EUCALYPTUS	REMAINS
ET-33	CUPANIOPSIS ANACARDIOIDES	REMAINS
ET-34	CUPANIOPSIS ANACARDIOIDES	REMAINS
ET-35	CUPANIOPSIS ANACARDIOIDES	REMAINS
ET-36	CUPANIOPSIS ANACARDIOIDES	REMAINS
ET-37	SYAGRUS ROMANZOFFIANA	REMOVE
ET-38	SYAGRUS ROMANZOFFIANA	REMOVE
ET-39	SYAGRUS ROMANZOFFIANA	REMOVE
ET-40	SYAGRUS ROMANZOFFIANA	REMOVE
ET-41	SYAGRUS ROMANZOFFIANA	REMOYE
ET-42	SYAGRUS ROMANZOFFIANA	REMOVE
ET-43	SYAGRUS ROMANZOFFIANA	REMOYE
ET-44	SYAGRUS ROMANZOFFIANA	REMOVE

ET-45	SYAGRUS ROMANZOFFIANA	REMOVE	
ET-46	SYAGRUS ROMANZOFFIANA	REMOVE	
ET-47	SYAGRUS ROMANZOFFIANA	REMOVE	
ET-48	SYAGRUS ROMANZOFFIANA	REMOYE	
ET-49	SYAGRUS ROMANZOFFIANA	REMOVE	
ET-50	SYAGRUS ROMANZOFFIANA	REMOVE	
ET-51	SYAGRUS ROMANZOFFIANA	REMOVE	or or other thanks of the same
ET-52	SYAGRUS ROMANZOFFIANA	REMOVE	
ET-53	SYAGRUS ROMANZOFFIANA	REMOYE	
		and see and an institution of the second	
- 1	EXISTING METALWORK	REMOVE	
	FENCE/GUARDRAIL: REMOVE AND		

 EXISTING METALWORK	REMOVE	
FENCE/GUARDRAIL: REMOVE AND		
RECYCLE		
 ALL BEDS: REMOVE &	REMOVE	***************************************
RECYCLE/DISPOSE ALL EXISTING		
SHRUBBERY AND GROUND COVER		
INCLUDING, BUT NOT LIMITED TO		
ALGERIAN IVY, BOTTLEBRUSH,		
VOLUNTEER SHRUBS AND NOXIOUS		
WEEDS, ETC.		

REMOVE AS MUCH EXISTING IRRIGATION SYTEM AS POSSIBLE. HEADS, RISERS AND SOME PIPELINE MAY BE ABANDONED IN PLACE BLW

GRD.	
 TREES TO BE REMOVED SHALL BE CUT	REMOVE
DOWN IN SECTIONS AND ROOTBALL	
REMOVED OR GRINDED TO MIN 12" BLW	

REMOVED OR GRINDED TO MIN 12" BLW GRD		
 TREES TO REMAIN SHALL BE	REMAINING	
PROTECTED THROUGHOUT THE		
COURSE OF CONSTRUCTION. TREES		
SHALL BE MAINTAINED BY MEANS OF		
REGULAR DEEP WATERING DURING		


KLOOLAK PLLI WATEKINO POKINO		
COURSE OF CONSTRUCTION.		
 CUPANIOPSIS ANACARDIOIDES,	REMAINING	*****
(CARROTWOODS) SHALL BE		
SELECTIVELY PRUNED REMOVING ONLY		
DEADWOOD, CONFLICTING BRANCHES		
AND WATERSPROUTS. CARROTWOOD		
OUTER CANOPIES SHALL BE SHAPED		
INTO A UNIFORM OUTWARD CURVE		
IIMBRELLA SHAPE		

	LANDSCAPE AND PELLBERG N	CILLE
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Date 11/18/21


Scale 1" = 20'-0" Drawn SPE

Job 21-1028-1

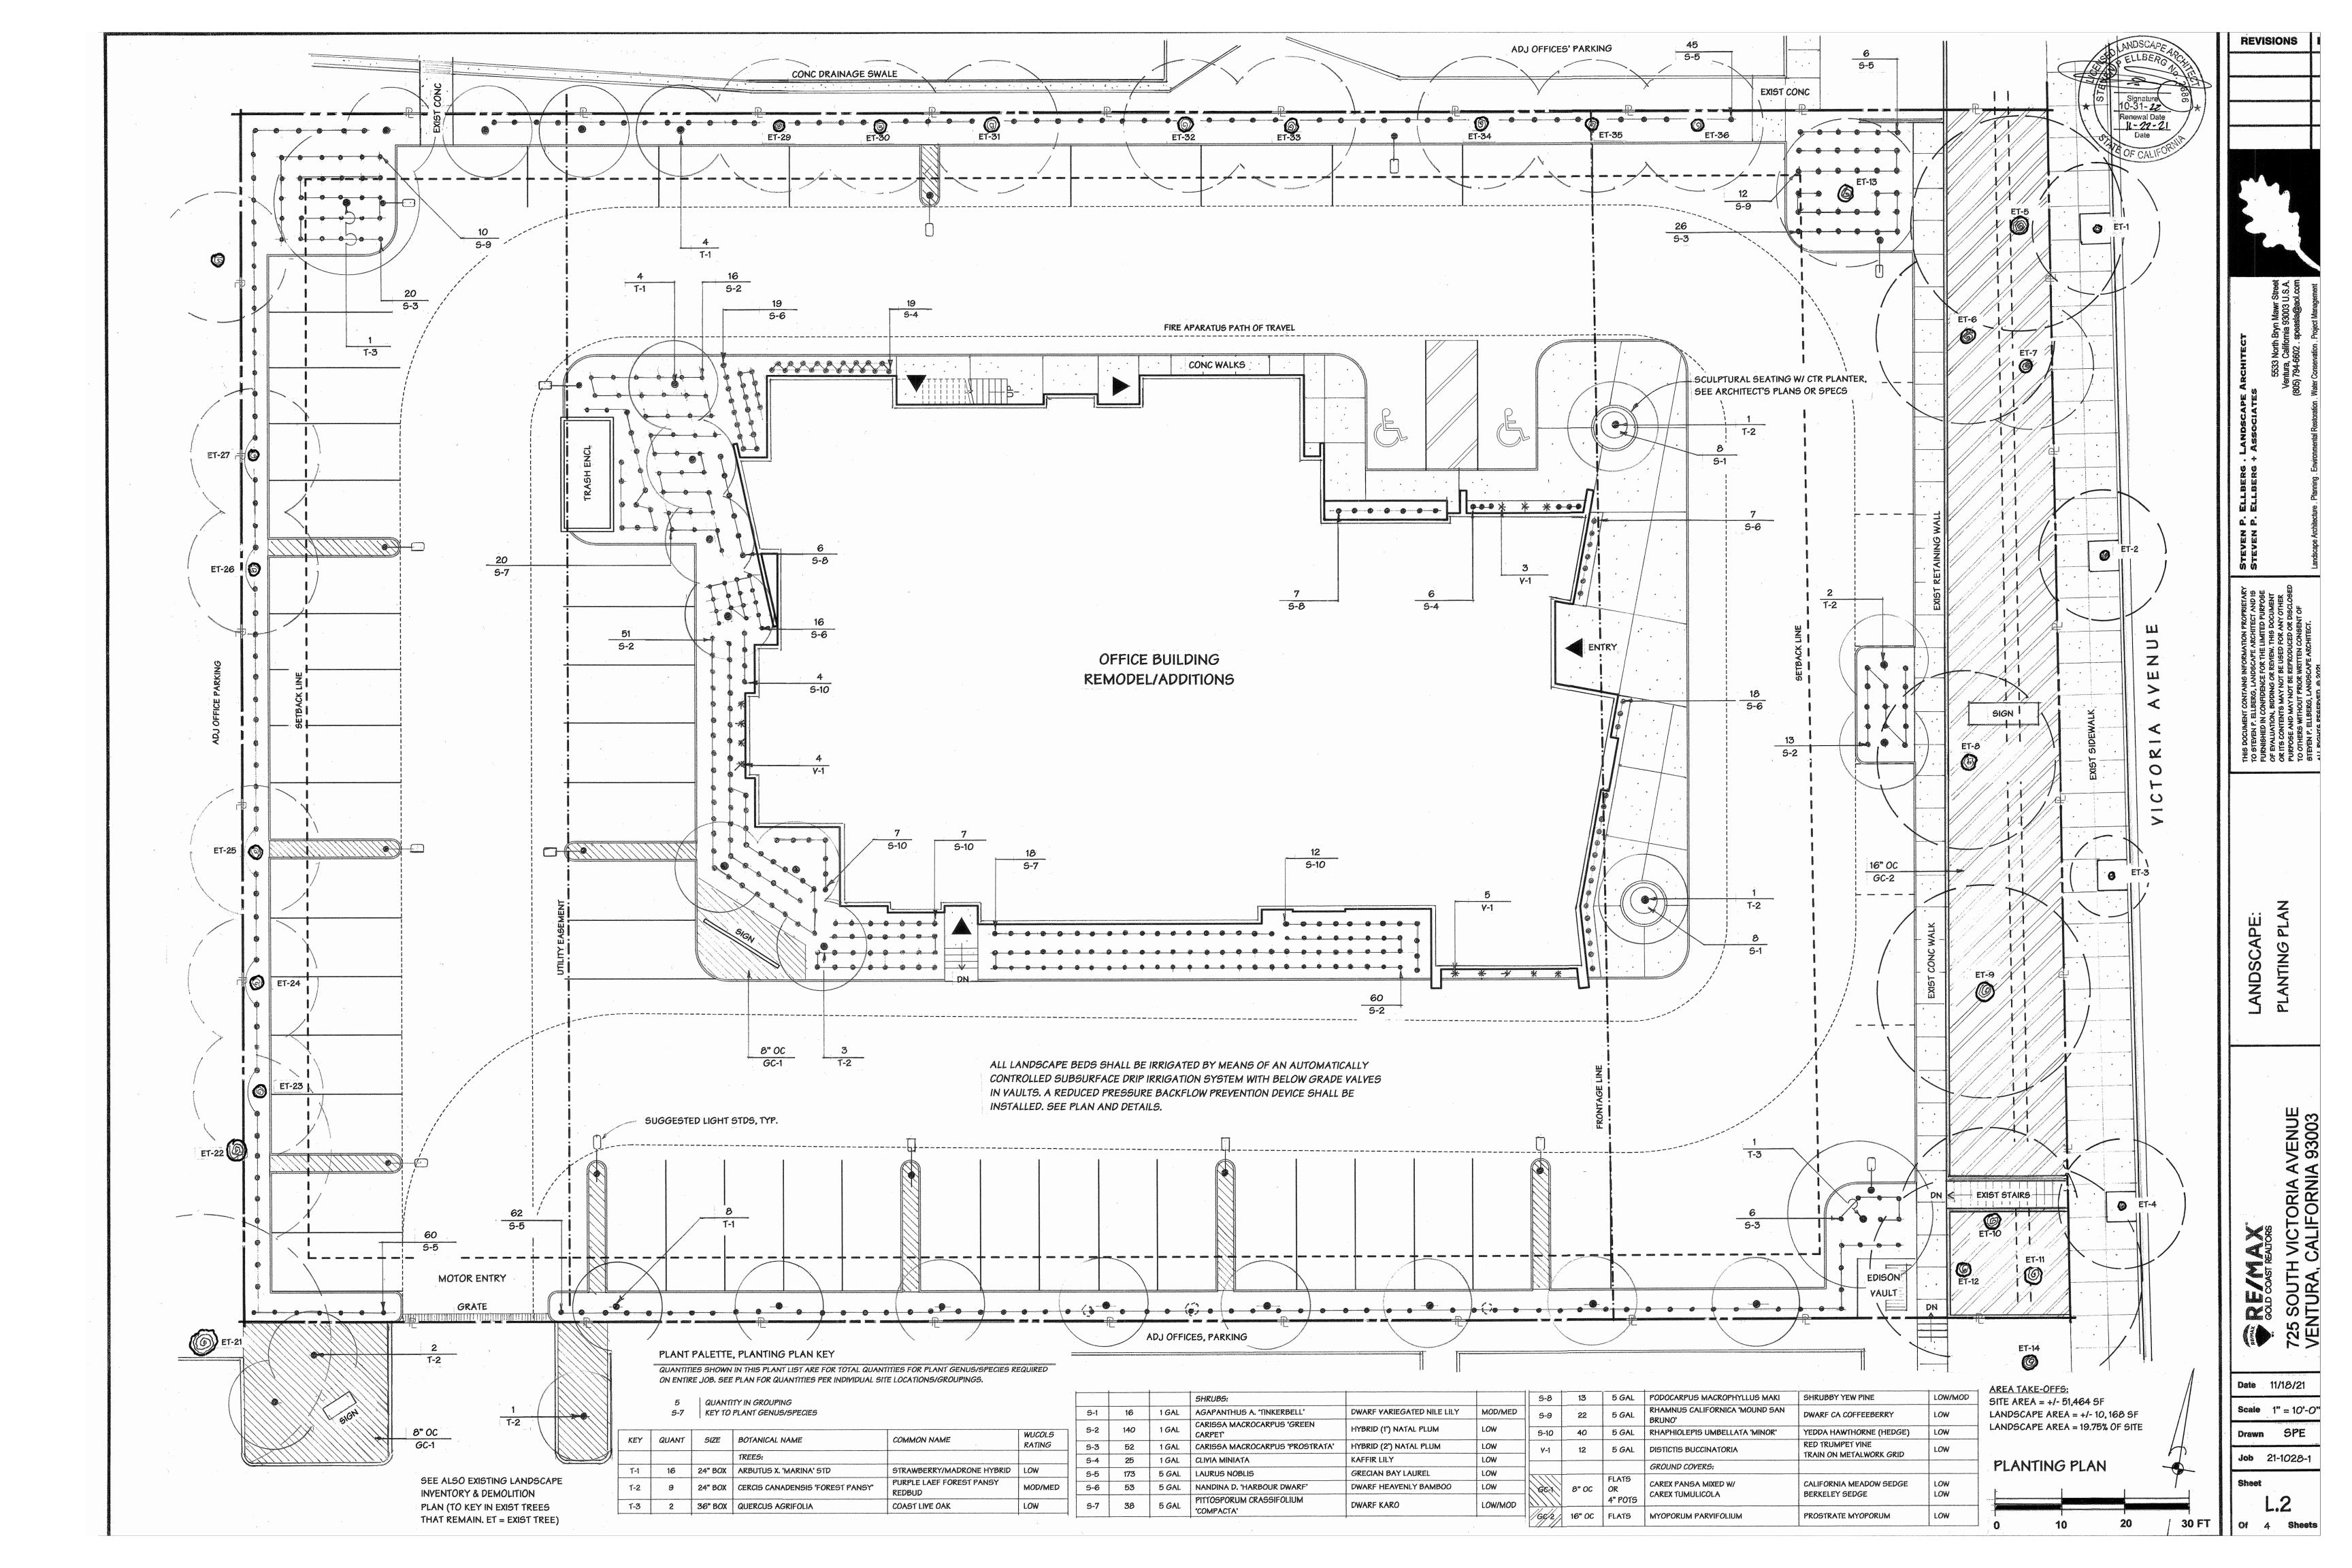


1) FINISH GRADE RAIN BIRD SEB 7XB (3) ½" AIR RELIEF VALVE: RAIN BIRD ARVO50
TO BE INSTALLED AT HIGH POINTS
IN DRIP ZONE (4) PVC SCH 40 FEMALE ADAPTER (5) PVC SCH 80 RISER (6) BRICK (1 OF 2) 7) PVC HEADER PIPE (8) PVC SCH 40 TEE (9) 3" MINIMUM DEPTH OF

XFS SUB-SURFACE DRIPLINE AIR RELIEF VALVE

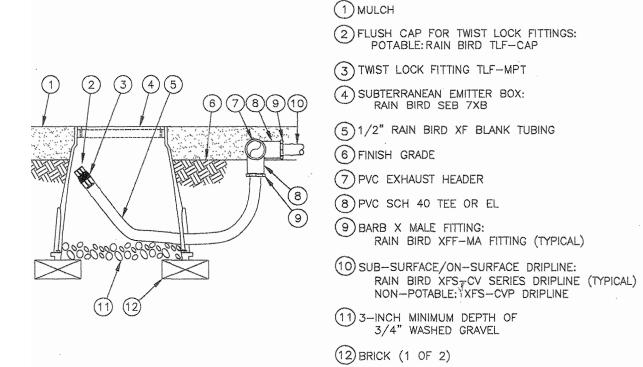


1. ALLOW A MINIMUM OF 6-INCHES OF DRIPLINE TUBING IN VALVE BOX IN ORDER TO DIRECT FLUSHED WATER OUTSIDE VALVE BOX.

XFS-CY SUB-SURFACE DRIPLINE FLUSH POINT

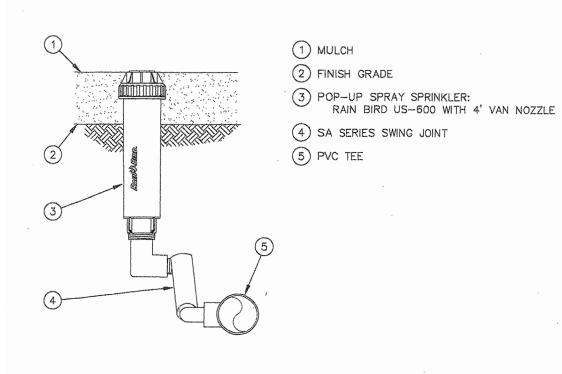


1. VAN NOZZLE MAY BE SET TO CLOSED, OR IF IT IS DESIRED TO SEE SPRAY FROM THE NOZZLE, SET THE ARC TO ½ PATTERN. THE FLOW FROM THE NOZZLE, 0.3 GPM, SHOULD BE ACCOUNTED FOR IN THE SYSTEM DESIGN.

XFS-CY SUB-SURFACE OPERATION INDICATOR

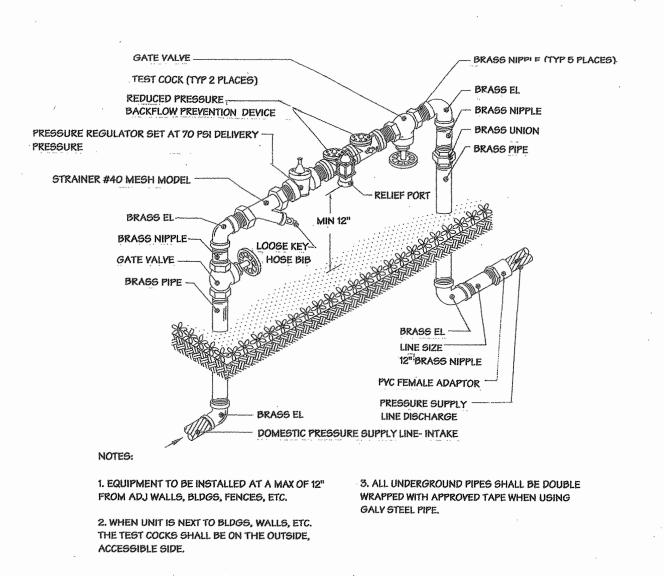

BACKFLOW PREVENTION DEVICE (RPBP)

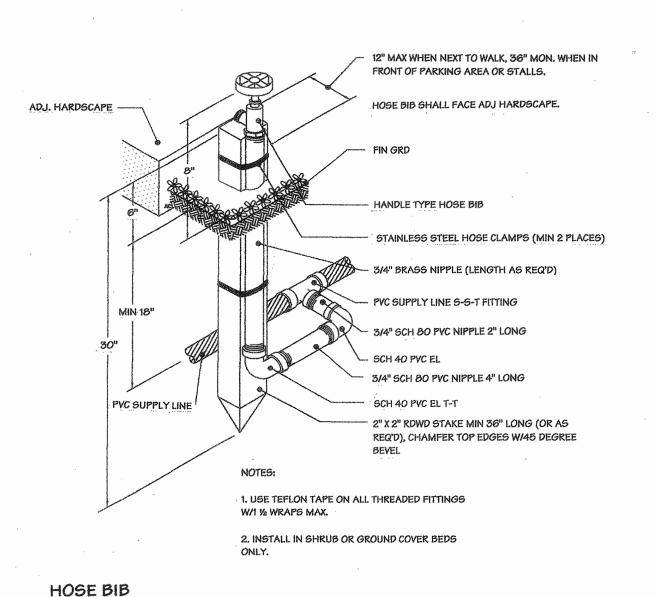


1) FINISH GRADE 2 ROUND VALVE BOX WITH COVER:
RAIN BIRD VB-10RND
WATERPROOF CONNECTION:
RAIN BIRD DB SERIES
VALVE ID TAG 5 30-INCH LINEAR LENGTH OF WIRE, COILED


(a) 1" x ¾" REDUCING COUPLING
(INCLUDED IN XCZ-100-PRF KIT) (7) PRESSURE REGULATING FILTER: RAIN BIRD PRF-075-RBY (INCLUDED IN XCZ-LF-100-PRF KIT) PVC SCH 40 FEMALE ADAPTOR OR REDUCER
(10) REMOTE CONTROL VALVE: RAIN BIRD LFV-100 (INCLUDED IN XCZ-LF-100-PRF KIT)

PVC SCH 40 ELL (12) PVC SCH 80 NIPPLE (LENGTH AS (13) PVC SCH 80 NIPPLE (2-INCH LENGTH, HIDDEN) AND PVC SCH 40 ELL)
PVC SCH 40 TEE OR ELL SIDE VIEW TOP VIEW (15) PVC MAINLINE (16) 3-INCH MINIMUM DEPTH OF 3/4-INCH WASHED GRAVEL


SUB-SURFACE DRIPLINE REMOTE CONTROL VALVE

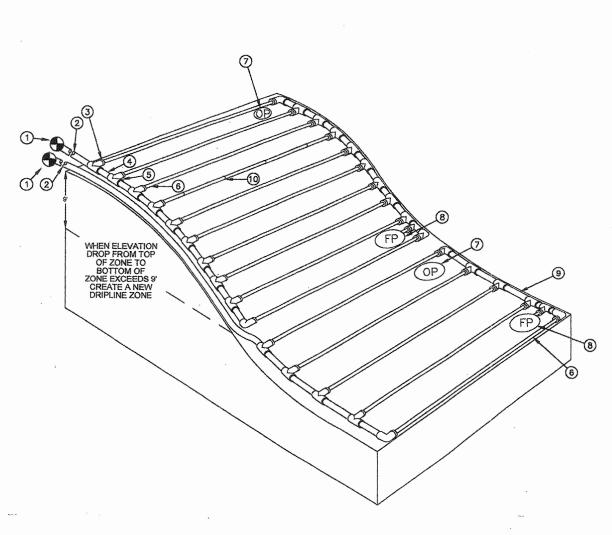

XFS-CV SUB-SURFACE STEEP SLOPE LAYOUT EXAMPLE

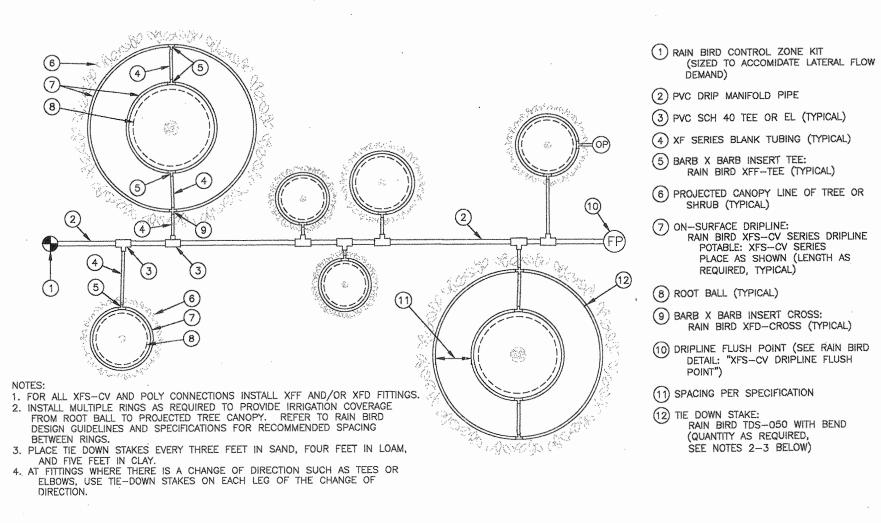

XFS-CV SUB-SURFACE DRIPLINE MULTI- TREE/SHRUB

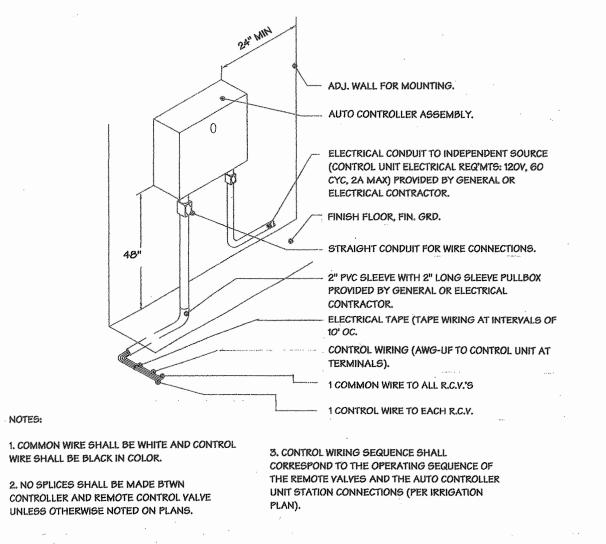

AUTOMATIC CONTROLLER

SUBSURFACE IRRIGATION GENERAL NOTES:

IRRIGATION CONTROL VALVE:
 RAIN BIRD XCZ DRIP CONTROL ZONE KIT
 INSTALLED IN VALVE BOX

2) PVC DRIP MANIFOLD FROM RAIN BIRD CONTROL ZONE VALVE KIT (SIZED TO MEET LATERAL

3 BARB X MALE FITTING: RAIN BIRD XFF-MA FITTING (TYPICAL)

5 PVC SCH 40 TEE OR EL (TYPICAL)

(6) SUB-SURFACE/ON-SURFACE DRIPLINE:

RAIN BIRD XFS-CV SERIES DRIPLINE (TYPICAL)
NON-POTABLE: XFS-CVP DRIPLINE

NUIES:

1. DISTANCE BETWEEN LATERAL ROWS AND EMITTER SPACING TO BE BASED ON SOIL TYPE, PLANT MATERIALS AND CHANGES IN ELEVATION, DISTANCE BETWEEN LATERAL ROWS FOR BOTTOM 1/3 OF SLOPE TO BE SPACED GREATER THAN OPTIMAL ROW DISTANCE. SEE RAIN BIRD XFD DRIPLINE INSTALLATION GUIDE FOR SUGGESTED SPACING.

SEC RAIN SIRD APD DRIPLINE INSTALLATION GOIDE FOR SIGGESTED SPACING.

2. LENGTH OF LONGEST DRIPLINE LATERAL SHOULD NOT EXCEED THE MAXIMUM LENGTH SHOWN IN THE ACCOMPANYING TABLE.

3. WHEN ELEVATION CHANGE EXCEEDS 10 FEET IT IS RECOMMENDED THAT A NEW DRIPLINE ZONE BE CREATED.

4. WHEN USING 17MM INSERT FITTINGS WITH DESIGN PRESSURE OVER 50PSI, IT IS RECOMMENDED THAT STAINLESS STEEL CLAMPS BE INSTALLED ON EACH FITTING.

PLACE AS SHOWN (LENGTH AS

REQUIRED, TYPICAL)

8 FLUSH POINT: SEE RAIN BIRD DETAIL "XFS-CV FLUSH POINT"

4 PVC SUPPLY HEADER

9 PVC FLUSH HEADER

1. IRRIGATION SYSTEM SHALL BE RAINBIRD XF SERIES SUBSURFACE DRIP. TO BE INSTALLED IN ACCORDANCE WITH MANUFACTURER SPECS AND BEST PRACTICES.

2. USE RAINBIRD XF-CHK SERIES O.6 GPH DRIPLINE WITH 12" OC EMITTER SPACING. DRIPLINE ROWS SHALL BE SET AT 20" OC EQUAL SPACING. DRIPLINES SHALL BE BURIED A UNIFORM DEPTH OF 4" BLW FIN GRD.

3. EACH SUBSURFACE DRIP IRRIGATION VALVE CIRCUIT SHALL HAVE AN AIR GAP DEVICE INSTALLED ON THE HIGHEST POINT OF CIRCUIT AND DRAIN DEVICES INSTALLED ON THE LOW POINT OF EACH CIRCUIT.

4. THIS PLAN DIAGRAMMATICALLY SHOWS DRIPLINE LAYOUT FOR ESTIMATING PURPOSES AND


REFERENCE. 5. THE EXACT LOCATIONS OF POC, VALVES, CONTROLLER, BACKFLOW PREVENTION MAY NEED TO BE

6. IN THE CASE WHERE ROCK, GRANITE SLOUGH. SHALLOW EXISTING TREE ROOTS ARE ENCOUNTERED: IRRIGATION DRIP LINES MAY HAVE TO BE SET ON SURFACE UTILIZING STEEL LANDSCAPE STAPLES SET AT 12" OC TO HOLD DOWN DRIPLINES: AND RELY ON TOPDRESSING TO COVER UP THE DRIPLINES.


7. WATERING SCHEDULES AND TIMES WILL VARY DUE TO CLIMATE, ORIENTATION, SEASON, WEATHER, SOIL TYPES AND PLANT NEEDS, ETC. THE INSTALLING CONTRACTOR SHALL ESTABLISH A WATER SCHEDULE AND WATERING DURATIONS AT TIME OF INSTALLATION COMPLETION FOR COMPLETE SUBSURFACE SOIL MOISTURE COVERAGE BETWEEN DRIPLINE ROWS.

NOTE THAT DUE TO DROUGHT CONDITIONS &/OR WATER CONSERVATION MEASURES- CITY AND/OR WATER AGENCY/DISTRICTS- WATER PRESSURE MAY HAVE BEEN, OR MAY BE, SUBJECT TO WATER PRESSURE DOWN-GRADES OR DELIVERY PRESSURE FLUCTUATIONS.

THE INTENT OF IRRIGATION SYSTEM IS TO PROVIDE MOST EFFICIENT DRIP IRRIGATION SYSTEM ON THE MARKET TODAY. THE IRRIGATION SYSTEM IS MEANT TO BE USED UNTIL PLANT MATERIAL ESTABLISHMENT PERIOD, (IN MOST CASES) AFTER 2-3 YEARS PLANT ESTABLISHMENT AND THEN AS SUPPLEMENTAL SUMMER IRRIGATION ONLY SEVERAL TIMES EACH SUMMER AND FALL.

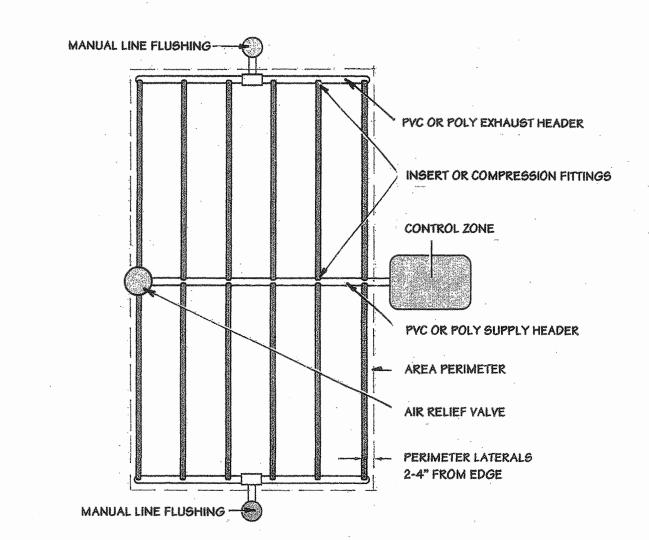

SUB-SURFACE DRIPLINE COMMON GRID CENTER FEED

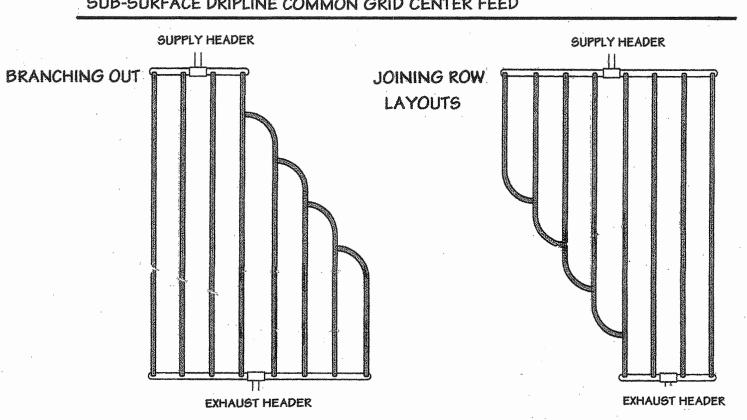

SUB-SURFACE DRIPLINE BRANCHING OUT, JOINING ROWS LAYOUTS



REVISIONS

Date 11/18/21

Scale PER DTLS Drawn SPE

Job 21-1028-1

